

# STEWART PARKWAY & PINE STREET PAVEMENT IMPROVEMENTS

PROJECT NO. 23PW01

**APRIL 2023** 

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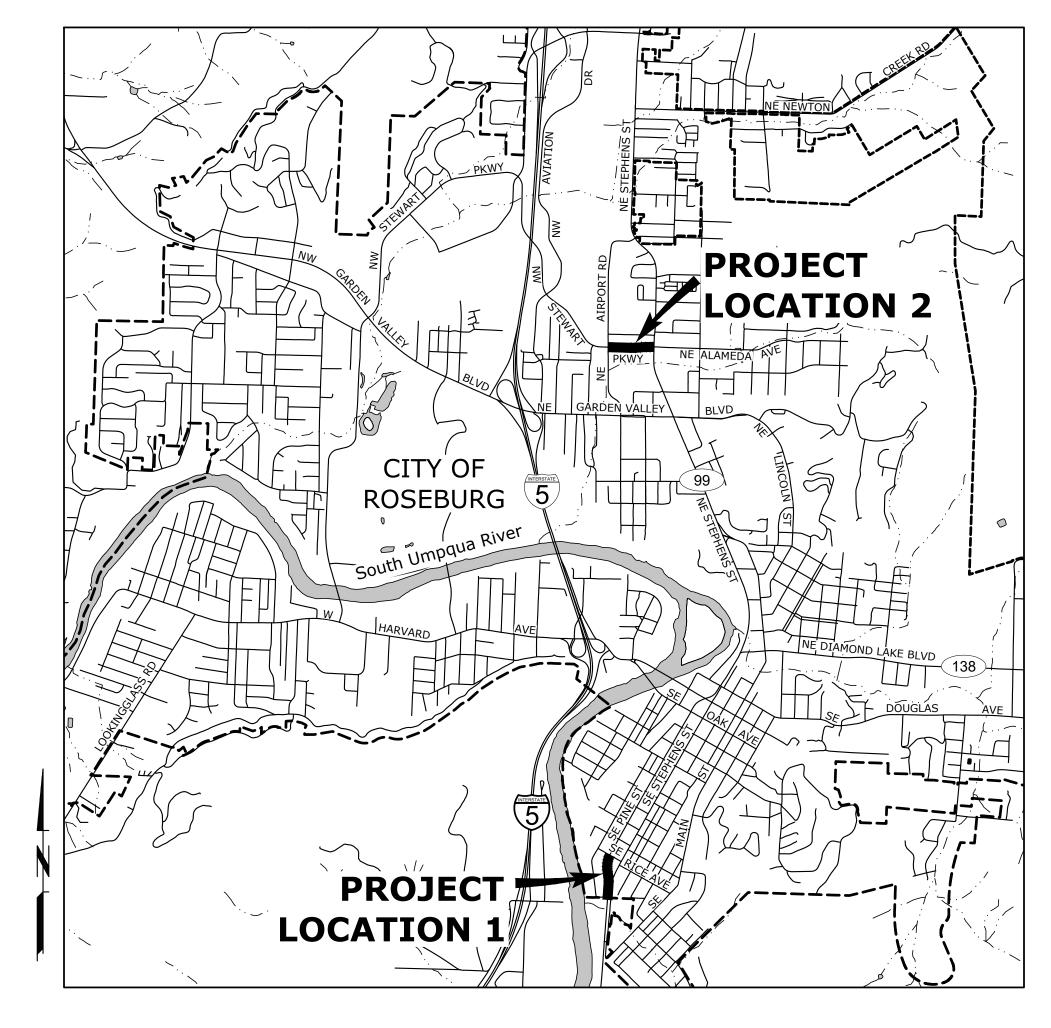
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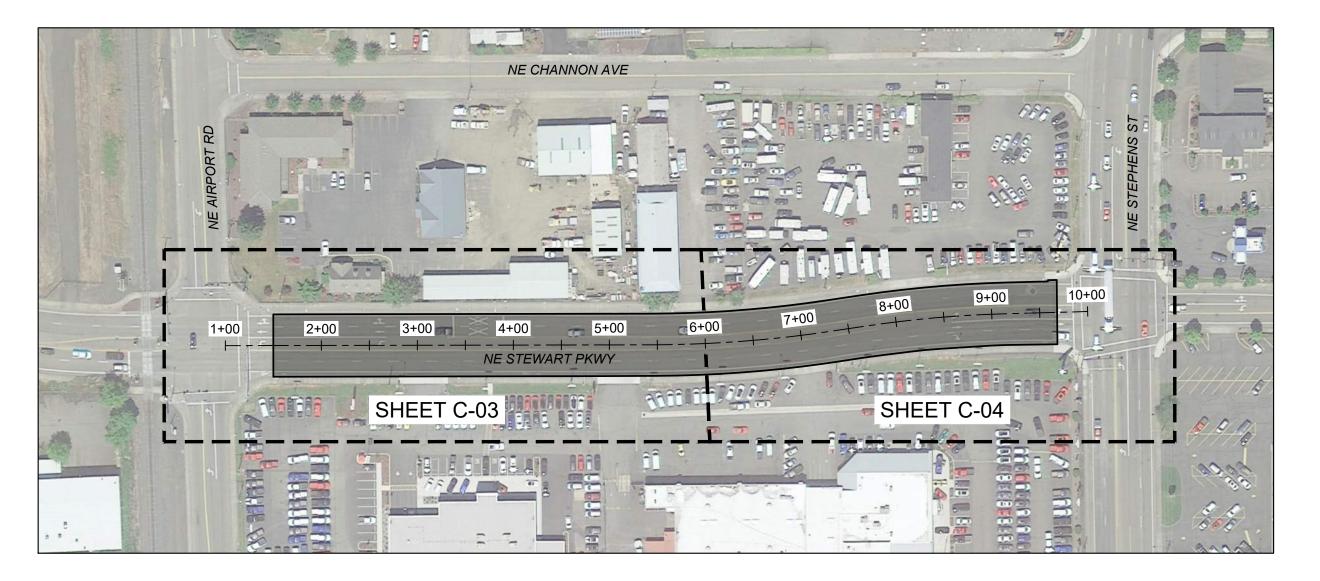
NON-FREEWAY MULTI-LANE SECTIONS NON-FREEWAY MULTI-LANE SECTIONS







ATTENTION: OREGON LAW REQUIRES THE CONTRACTOR TO FOLLOW THE RULES ADOPTED BY THE OREGON UTILITY NOTIFICATION CENTER. THOSE RULES ARE SET FORTH IN OAR 952-001-0010 THROUGH OAR 952-001-0090. THE CONTRACTOR MAY OBTAIN COPIES OF THE RULES BY CALLING THE UTILITY NOTIFICATION CENTER. (NOTE: THE TELEPHONE NUMBER FOR THE OREGON UTILITY NOTIFICATION CENTER IS 503-246-6699.)






#### SHEET LAYOUT

SCALE: 1" = 100'

NO.	DATE	BY	REVISION	SCALE		DESIGNED:
				PLAN	AS SHOWN	A. FISCHER
						DRAWN:
					HORIZ.	A. FISCHER
				PROFILE	VERT.	CHECKED:
						R. VOORHIES
				ONE INCH (REF)		CWE PROJECT NO.
!						40193.023.01





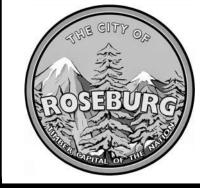

LN LT

> 900 SE DOUGLAS AVE. ROSEBURG, OR 97470

LANE

LEFT

**ABBREVIATIONS** 

ABANDON(ED)

AGGREGATE

APPROXIMATE(LY)

AIR RELEASE VALVE

ALUMINUM

APPROVED

**ASSEMBLY** 

BEGIN

**BACKFILL** 

BOTTOM

**BETWEEN** 

BENCHMARK

CENTER LINE

CATCH BASIN

ASPHALTIC CONCRETE

ASPHALTIC CONCRETE PAVEMENT

AMERICAN NATIONAL STANDARDS INSTITUTE

AMERICAN PUBLIC WORKS ASSOCIATION

AMERICAN WATER WORK ASSOCIATION

AVERAGE DRY WEATHER FLOW

ABAN

 $\mathsf{AC}$ 

ACP

**ADWF** 

AGG

**ANSI** 

**APPROX** 

APPVD

**APWA** 

**ASSY** 

**AWWA** 

ARV

BEG

BM BTM

BFILL

**BETW** 

C/L

CB

AL

CITY PROJECT #: 23PW01
CITY PROJECT MANAGER
RICK CASTLE

#### **SHEET LAYOUT & ABBREVIATIONS**

WITH

WITHIN

WITHOUT

MAINTAIN

MAXIMUM

MINIMUM

MATERIAL(S)

MANHOLE(S)

**MODIFICATION** 

MONUMENT(S)

NORTHBOUND

NOT TO SCALE

OUTSIDE DIAMETER

OVERHEAD LINE

POINT OF CURVE

PORTLAND CEMENT CONCRETE

NUMBER

**NOMINAL** 

ON CENTER

**POWER** 

MANUFACTURER('S)

MANUAL OF UNIFORM TRAFFIC CONTROL DEVICES

OREGON DEPARTMENT OF TRANSPORTATION

MAINT

MAX

MATL(S)

MFR(S)

MH(S)

MIN

MOD

NB

NO

NOM

NTS

OC

OD

PC

PCC

ODOT

OVHD

MON(S)

MUTCD

G-02

SHEET NO.

STEWART PARKWAY & PINE STREET PAVEMENT IMPROVEMENTS
APRIL 2023

2 OF 13

CCTV **CLOSED CIRCUIT TELEVISION PCMS** PORTABLE CHANGEABLE MESSAGE SIGN CDF CONTROLLED DENSITY FILL PCVC POINT OF CURVATURE ON VERTICAL CURVE CIPP **CURED IN PLACE PIPE** PLAIN END PE CURB/GUTTER CG PERF PERFORATED PERM CL CLASS **PERMANENT** CLR CLEAR PΙ POINT OF INTERSECTION CLSM PIVC CONTROLLED LOW STRENGTH MATERIAL POINT OF INTERSECTION ON VERTICAL CURVE CO CLEANOUT PARKING PΚ COMM COMMUNICATIONS P/L PROPERTY LINE CONC CONCRETE **PLACE PRESSURE** CONN CONNECTION **PRESS** CONST PROP PROPOSED CONSTRUCT/CONSTRUCTION COORD COORDINATE PSI POUNDS PER SQUARE INCH COR CITY OF ROSEBURG PT POINT OF TANGENCY CP CONCRETE PIPE PVC POLYVINYL CHLORIDE **CPLG** COUPLING **PVMT PAVEMENT** CR CRUSHED ROCK PWPUBLIC WORKS CY **CUBIC YARD** RADIUS DBH DIAMETER AT BREAST HEIGHT REHAB REHABILITATE/REHABILITATION DET(S) DETAIL(S) REQ'D REQUIRED DI **DUCTILE IRON** RT RIGHT RIGHT OF WAY DIAMETER DIA R/W DR DRIVE SB SOUTHBOUND DWG DRAWING DWY DRIVEWAY SCHED SCHEDULE STORM DRAIN SD EΑ EACH STORM DRAIN MANHOLE SDMH EΒ **EASTBOUND** SHT(S) SHEET(S) SLOPE **ELEVATION SPECS** SPECIFICATIONS ELEC/E **ELECTRICAL** SQUARE EOP **EDGE OF PAVEMENT** SQ SQ FT SS SQUARE FOOT EQ **EQUAL** EQUIP EQUIPMENT SANITARY SEWER SANITARY SEWER CLEANOUT ESC **EROSION/SEDIMENTATION CONTROL** SSCO **ESMT EASEMENT** SSMH SANITARY SEWER MANHOLE **EXIST** SST **EXISTING** STAINLESS STEEL ST STREET EG **EXISTING GRADE** STA STATION FG FINISHED GRADE STD STANDARD FLOW LINE STL STEEL **SIDEWALK** FΜ FORCE MAIN S/W FIBER OPTIC FO FT FEET/FOOT T/TEL **TELEPHONE** TAN **TANGENT** GAS TBD TO BE DETERMINED GRADE GR TBM TEMPORARY BENCH MARK GRAVEL GRVL TCM TRAFFIC CONTROL MEASURES TCP GV **GATE VALVE** TRAFFIC CONTROL PLAN TEMP **TEMPORARY** THICK/THICKNESS **HMAC** HOT MIX ASPHALT CONCRETE THK **HDPE** HIGH DENSITY POLYETHELENE THRU THROUGH TELEVISION **HORIZ** HORIZONTAL TV HWY HIGHWAY TYP **TYPICAL** ID IDENTIFICATION/INSIDE DIAMETER USDOT UNITED STATES DEPARTMENT OF TRANSPORTATION INVERT ELEVATION **INSTL INSTALL VERT** VERTICAL(LY) IR IRON ROD WATER LATERAL LAT WESTBOUND LINEAR FEET WZ **WORK ZONE** 

W/

W/IN

W/O

ATIONS.dwg 4/10/2023 3:18 PM Anthony Fischer

3. IT SHALL BE THE RESPONSIBILITY OF THE CONTRACTOR TO VERIFY ALL UTILITY LOCATIONS PRIOR TO CONSTRUCTION AND ARRANGE FOR THE RELOCATION OF ANY UTILITIES IN CONFLICT WITH THE PROPOSED CONSTRUCTION. THE LOCATIONS, DEPTH AND DESCRIPTION OF EXISTING UTILITIES SHOWN WERE COMPILED FROM AVAILABLE RECORDS. THE ENGINEER OR UTILITY COMPANIES DO NOT GUARANTEE THE ACCURACY OR THE COMPLETENESS OF SUCH RECORDS. ADDITIONAL UTILITIES, OTHER THAN THOSE SHOWN, MAY EXIST WITHIN THE WORK AREA.

4. OREGON LAW REQUIRES THAT THE RULES ADOPTED BY OREGON UTILITY NOTIFICATION CENTER BE FOLLOWED. THOSE RULES ARE SET FORTH IN OAR 952-001-0010 THROUGH OAR 952-001-0090. YOU MAY OBTAIN COPIES OF THE RULES BY CALLING THE CENTER OR ACCESSING VIA INTERNET AT WWW.CALLBEFOREYOUDIG.ORG. CALL BEFORE YOU DIG - 811.

5. THE CONTRACTOR SHALL MAKE PROVISIONS TO KEEP ALL EXISTING UTILITIES IN SERVICE AND PROTECT THEM DURING CONSTRUCTION. CONTRACTOR SHALL IMMEDIATELY REPAIR OR REPLACE ANY DAMAGED UTILITIES USING MATERIALS AND METHODS APPROVED BY THE UTILITY OWNER. NO SERVICE INTERRUPTIONS SHALL BE PERMITTED WITHOUT PRIOR WRITTEN AGREEMENT WITH THE UTILITY PROVIDER.

6. CONTRACTOR SHALL NOTIFY THE ENGINEER AND THE CITY OF ROSEBURG 48 HOURS IN ADVANCE OF STARTING CONSTRUCTION AND 24 HOURS BEFORE RESUMING WORK AFTER SHUTDOWNS, EXCEPT FOR NORMAL RESUMPTION OF WORK FOLLOWING SATURDAYS, SUNDAYS, OR HOLIDAYS.

7. CONTRACTOR SHALL REMOVE AND DISPOSE OF CONCRETE, ASPHALT CEMENT, TOPSOIL, AND OTHER MATERIAL IN THE WORK LIMITS AND WHERE INDICATED ON THE PLANS. MATERIAL SHALL BE DISPOSED OF IN SUCH A MANNER AS TO MEET ALL APPLICABLE REGULATIONS. CONTRACTOR SHALL ENSURE RECIPIENTS OF FILL MATERIALS REMOVED OFFSITE ARE PERMITTED TO RECEIVE SAID MATERIALS REGARDLESS OF THE RECEIVING JURISDICTION.

8. LIMIT HOURS OF CONSTRUCTION TO BETWEEN 7:00 PM TO 6:00 AM, MONDAY THROUGH FRIDAY. CONSTRUCTION IN ALL PROJECT AREAS IS PROHIBITED ON SATURDAYS, SUNDAYS AND HOLIDAYS, AS STATED IN SECTION 220.40(E) OF THE SPECIAL PROVISIONS. SEE TRAFFIC REROUTING PLANS AND SECTION 00220 OF THE SPECIAL PROVISIONS FOR ALLOWABLE LANE CLOSURES.

9. THE CONTRACTOR SHALL KEEP AN APPROVED SET OF PLANS ON THE PROJECT SITE AT ALL TIMES.

10. IT IS THE CONTRACTOR'S RESPONSIBILITY TO VISIT THE SITE AND VERIFY ALL EXISTING CONDITIONS BEFORE THE START OF WORK. THE CONTRACTOR SHALL TAKE ALL NECESSARY FIELD MEASUREMENTS AND OTHERWISE VERIFY ALL DIMENSIONS AND EXISTING CONSTRUCTION CONDITIONS INDICATED AND/OR SHOWN ON THE PLANS. SHOULD ANY ERROR OR INCONSISTENCY EXIST, THE CONTRACTOR SHALL NOT PROCEED WITH THE WORK AFFECTED UNTIL REPORTED TO THE ENGINEER FOR CLARIFICATION OR CORRECTION.

11. ANY INSPECTION BY THE CITY, COUNTY, STATE, FEDERAL AGENCY OR ENGINEER SHALL NOT, IN ANY WAY, RELIEVE THE CONTRACTOR FROM ANY OBLIGATION TO PERFORM THE WORK IN COMPLIANCE WITH THE APPLICABLE CODES, REGULATIONS, CITY STANDARDS AND PROJECT CONTRACT DOCUMENTS.

12. CONTRACTOR SHALL COORDINATE ALL IMPROVEMENT LIMITS WITH THE ENGINEER ONSITE PRIOR TO BEGINNING WORK. NO PAYMENT WILL BE MADE FOR EXTRA WORK THAT IS CONSTRUCTED BEYOND THE APPROVED CONSTRUCTION LIMITS.

13. AT THE END OF EACH WORK DAY, THE CONTRACTOR SHALL CLEAN UP THE PROJECT AREA AND LEAVE IT IN A NEAT AND SECURED MANNER. UPON COMPLETION OF THE PROJECT, THE CONTRACTOR SHALL LEAVE THE PROJECT AREA FREE FROM ALL DEBRIS AND UNUSED MATERIALS.

14. PROPERTY LINES SHOWN ON PLAN SHEETS ARE APPROXIMATE AND FOR GENERAL DELINEATION PURPOSES ONLY AND ARE NOT MEANT TO REPRESENT THE ACTUAL PROPERTY BOUNDARIES.

15. THE CONTRACTOR SHALL BE SOLELY RESPONSIBLE FOR COMPLYING WITH ALL CONSTRUCTION SAFETY, HEALTH AND OTHER RULES AND REGULATIONS FROM OSHA, DEQ, STATE, AND LOCAL REGULATING AGENCIES FOR SAFETY AND INSTALLATION OF THE WORK INCLUDING, BUT NOT LIMITED TO, SHORING, BRACING, ERECTION/INSTALLATION, FALL PROTECTION, GUARDRAILS, ETC.

16. REPLACE CURBS, SIDEWALKS, AND/OR DRIVEWAY APRONS THAT ARE DAMAGED AS A RESULT OF CONSTRUCTION OPERATIONS. REPLACE FULL SECTIONS TO THE NEAREST EXISTING CONSTRUCTION JOINT. REPLACEMENT WILL BE CONSIDERED INCIDENTAL TO THE WORK.

17. ALL CONSTRUCTION SURVEY AND STAKING REQUIRED FOR THE PROJECT SHALL BE PROVIDED BY THE CONTRACTOR. THE CONTRACTOR SHALL DEVELOP AND MAKE ALL DETAIL SURVEYS NECESSARY FOR LAYOUT AND CONSTRUCTION INCLUDING EXACT COMPONENT LOCATION (SUCH AS EXISTING STRIPING, SYMBOLS, DETECTOR LOOPS, ETC), WORKING POINTS, LINES, AND ELEVATIONS. PRIOR TO CONSTRUCTION, THE FIELD LAYOUT SHALL BE REVIEWED BY THE ENGINEER

18. THE CONTRACTOR SHALL HAVE THE RESPONSIBILITY TO CAREFULLY PRESERVE BENCHMARKS, REFERENCE POINTS AND STAKES, AND IN THE CASE OF DESTRUCTION THEREOF BY THE CONTRACTOR RESULTING FROM ITS NEGLIGENCE, THE CONTRACTOR SHALL BE CHARGED WITH THE EXPENSE AND DAMAGE RESULTING THEREFORE AND SHALL BE RESPONSIBLE FOR ANY MISTAKES THAT MAY BE CAUSED BY THE UNNECESSARY LOSS OR DISTURBANCE OF SUCH MARKS, REFERENCE POINTS AND STAKES.

19. CONTRACTOR IS RESPONSIBLE FOR SURVEYING AND REPLACING ALL MONUMENTS DISTURBED BY PAVING OR CONCRETE WORK PURSUANT TO ORS 209.150, AND FOR PREPARING AND FILING A RECORD OF SURVEY TO THE COUNTY SURVEYOR'S OFFICE PURSUANT TO ORS 209.250.

20. COORDINATE WITH OTHER CONTRACTORS WITHIN THE PROJECT LIMITS COMPLETING WORK. IF APPLICABLE, SEE THE GENERAL CONDITIONS OF THE SPECIFICATIONS FOR CONTACT INFORMATION.

21. PROTECT FRESHLY POURED CONCRETE CURBS AND SIDEWALK FROM VANDALISM OR OTHER DAMAGE FOR A MINIMUM OF TWENTY-FOUR (24) HOURS OR UNTIL CURED ENOUGH TO SUPPORT TYPICAL USE, WHICHEVER IS LONGER. ANY CURB OR SIDEWALK DAMAGED BY VANDALISM OR OTHER CAUSES SHALL BE REPLACED AT NO COST TO THE CITY.

22. CONTRACTOR SHALL RESTORE ALL DISTURBED LANDSCAPING AND IRRIGATION. PLACE TOPSOIL, AGGREGATE, AND/OR BARK MULCH WHERE SHOWN.

23. FURNISH AND PLACE DOWELS TO JOIN NEW CONCRETE WALKS, CURBS AND DRIVEWAYS TO EXISTING CONCRETE AS DIRECTED.

#### **EROSION CONTROL NOTES**

1. ALL EROSION AND SEDIMENT CONTROL MEASURES ARE TO BE PLACED PRIOR TO ANY DISTURBANCE CAUSED BY GRADING AND SHALL CONFORM TO THE REQUIREMENTS OF STATE AND FEDERAL REGULATIONS AND TO THE SPECIFIC REQUIREMENTS CONTAINED IN THE SPECIFICATIONS.

2. EXISTING INLETS AND CATCH BASINS THAT MAY RECEIVE RUNOFF FROM THE PROJECT AREA ARE TO BE PROTECTED PRIOR TO CONSTRUCTION. ALL INLETS AND CATCH BASINS ARE TO BE PROTECTED IN ACCORDANCE WITH ODOT/APWA STANDARDS FOR EROSION AND SEDIMENT CONTROL.

3. IN THE EVENT OF ANY EROSION CONTROL MEASURE FAILURE, IMMEDIATE ACTION SHALL BE TAKEN TO REPAIR, REPLACE, OR CONSTRUCT ADDITIONAL MEASURES AS REQUIRED TO ENSURE ADEQUATE EROSION CONTROL PROTECTION.

4. ALL EROSION CONTROL MEASURES SHALL BE INSPECTED REGULARLY, PARTICULARLY DURING AND AFTER STORM EVENTS, TO ENSURE ADEQUATE PERFORMANCE. MAINTENANCE AND INSPECTION LOGS SHALL REMAIN ON SITE AND SHALL BE AVAILABLE TO THE CITY OF ROSEBURG UPON REQUEST.

5. ALL PESTICIDES, PETROLEUM PRODUCTS, CHEMICALS OR OTHER POTENTIAL POLLUTANTS SHALL BE ADMINISTERED RESPONSIBLY WITH DISPOSAL AND SPILLS HANDLED IN ACCORDANCE WITH ALL LOCAL STATE AND FEDERAL REQUIREMENTS.

#### PAVING NOTES

1. TRIM VEGETATION AS NEEDED PRIOR TO PAVING TO ENSURE ALL VEGETATION IS CLEAR OF PAVING OPERATIONS.

2. ALL EDGES REMAINING AFTER COLD PLANE PAVEMENT REMOVAL, IF APPLICABLE, SHALL BE VERTICAL TO ACCEPT THE SUCCEEDING FULL DEPTH ASPHALT LIFT.

3. ALL JOINTS BETWEEN NEW ASPHALTIC CONCRETE AND EXISTING OR NEW ASPHALTIC CONCRETE AND CONCRETE SHALL BE TACKED AND SAND SEALED.

4. PROVIDE MINOR ADJUSTMENTS IN GRADE OF NEW A.C. AS REQUIRED TO FACILITATE DRAINAGE INTO STORM DRAINAGE FACILITIES. NO PONDING SHALL OCCUR BETWEEN CATCH BASINS FOLLOWING CONSTRUCTION.

5. THE MAXIMUM EXPOSURE AT DRIVEWAYS SHALL BE 3/4-INCH.

6. WHERE PAVEMENT IS TO BE REPLACED TO MATCH EXISTING GRADE ADJACENT TO EXISTING CURB, CONTRACTOR SHALL MARK EXISTING CURB FLOW LINE WITH PAINT PRIOR TO A.C. SURFACING REMOVAL.

7. COORDINATE WITH CITY STAFF FOR IN-GROUND VALVE, MANHOLE OR VAULT ADJUSTMENT OF FRANCHISE UTILITY ASSETS.

#### STRIPING AND SIGNING NOTES

1. ALL SIGNING AND PAVEMENT MARKING MATERIAL AND WORKMANSHIP SHALL CONFORM TO THE REQUIREMENTS AND SPECIFICATIONS OF THE MANUAL ON UNIFORM TRAFFIC CONTROL DEVICES (MUTCD), AND 2021 APWA STANDARD SPECIFICATIONS.

2. ALL LONGITUDINAL STRIPING SHALL BE PAINT. TRANSVERSE PAVEMENT MARKINGS, INCLUDING CROSSWALKS, STOP BARS, BIKE SYMBOLS, ARROWS, AND STORM INLET MARKINGS, SHALL BE PREFORMED THERMOPLASTIC AS SHOWN AND SPECIFIED. CONTRACTOR IS RESPONSIBLE FOR LAYOUT AND STAKING OF ALL TRANSVERSE PAVEMENT MARKINGS.

3. TEMPORARY FLEXIBLE PAVEMENT MARKERS ARE ALLOWED PRIOR TO STRIPING FOR A MAXIMUM PERIOD OF 14 CALENDAR DAYS.

4. CONTRACTOR SHALL OBTAIN CITY APPROVAL OF STRIPING LAYOUT 24 HOURS BEFORE STRIPING.

5. LANE DIMENSIONS SHALL BE MEASURED FROM CENTER OF STRIPE OR FROM EDGE OF PAVEMENT OR CURB TO CENTER OF STRIPE.

6. ALL PAVEMENT MARKINGS SHALL BE INSTALLED IN ACCORDANCE WITH ODOT TM500 SERIES DETAILS.

7. EXISTING STRIPING SHALL BE REMOVED AS NECESSARY PRIOR TO INSTALLATION OF NEW STRIPING.

#### TRAFFIC CONTROL NOTES

1. TRAFFIC CONTROL/DETOUR PLANS SHALL BE PREPARED BY THE CONTRACTOR. THE DRAFT CONCEPT TRAFFIC CONTROL PLAN MUST BE APPROVED BY THE CITY PRIOR TO THE PRE-CONSTRUCTION CONFERENCE. THIS PLAN DOES NOT RELIEVE THE CONTRACTOR FROM SUBMITTING DETAILED TRAFFIC CONTROL PLANS AS REQUIRED DURING CONSTRUCTION.

2. THE CONTRACTOR SHALL PROVIDE TEMPORARY PROTECTION AND DIRECTION OF TRAFFIC IN ACCORDANCE WITH THE MANUAL OF UNIFORM TRAFFIC CONTROL DEVICES, ODOT STANDARD DRAWINGS, ODOT STANDARD SPECIFICATIONS, AND CONTRACT SPECIAL PROVISIONS.

3. USE TEMPORARY PAVEMENT MARKERS, BARRIERS, BARRICADES, AND SIGNS AS REQUIRED TO SAFELY DETOUR PEDESTRIAN AND VEHICULAR TRAFFIC AROUND CONSTRUCTION. LABEL TYPE AND LOCATION FOR ALL ITEMS ON TRAFFIC CONTROL PLANS.

4. APPROPRIATE METHODS OF PEDESTRIAN AND VEHICULAR TRAFFIC CONTROL, INCLUDING FLAGGERS, SHALL BE EMPLOYED BY THE CONTRACTOR TO THE EXTENT DEEMED NECESSARY BY THE TRAFFIC CONTROL SUPERVISOR AND AS APPROVED BY THE CITY AND THE ENGINEER TO PROTECT WORKERS OR THIRD PARTIES AND SAFELY ACCOMMODATE TRAFFIC THROUGH THE WORK ZONE.

5. THE CONTRACTOR SHALL COORDINATE ACCESS TO DRIVEWAYS WITH PROPERTY OWNERS. ACCESS TO ROADWAY APPROACHES WITHIN THE PROJECT LIMITS SHALL BE MAINTAINED AT ALL TIMES. TRAFFIC PLATES SHALL BE USED, AND SECURED IN A MANNER ACCEPTABLE TO THE CITY, ACROSS ALL TRENCHES BLOCKING DRIVEWAYS TO PROVIDE ACCESS AT ALL TIMES. AT NO TIME SHALL CONTRACTORS DETAIN OR DELAY EMERGENCY VEHICLES.

6. THE CONTRACTOR SHALL COORDINATE ACCESS FOR SERVICES INCLUDING, BUT NOT LIMITED TO, MAIL DELIVERY, TRASH PICKUP, SCHOOL TRANSPORTATION, AND ANY OTHER SPECIAL TRANSPORTATION SERVICES THAT EXIST WITHIN THE PROJECT AREA.

7. EXISTING SIGNS THAT CONFLICT WITH CONSTRUCTION SIGNING SHALL BE COVERED OR REMOVED DURING CONSTRUCTION AND REPLACED AFTER CONSTRUCTION.

8. PROVIDE ACP WEDGES FOR LONGITUDINAL AND TRANSVERSE JOINTS ACCORDING TO 00620.40(d), 00744.44 AND 00744.45.


9. THE CONTRACTOR SHALL PROVIDE SAFE, STABLE, AND ACCESSIBLE ACCESS TO ALL DRIVEWAY AND PEDESTRIAN PATHS CONNECTING TO FRONT DOORS AT ALL TIMES. TEMPORARY INTERRUPTIONS IN ACCESS SHALL BE COORDINATED BY THE CONTRACTOR WITH THE PROPERTY OWNER OR OCCUPANT AS REQUIRED.

10. CONTRACTOR SHALL FURNISH PORTABLE CHANGEABLE MESSAGE SIGN AT WORK ZONES ON ARTERIAL ROADS IN ACCORDANCE WITH THE SPECIFICATIONS.


11. COLD PLANE PAVEMENT REMOVAL SHALL BE COMPLETED ON THE SAME SHIFT AS THE PERMANENT ASPHALT PAVEMENT WEARING COURSE, UNLESS OTHERWISE APPROVED BY ENGINEER.



9						
$\vdash$	DATE	BY	REVISION	SCALE		DESIGNED:
City of 021-PMP				PLAN PROFILE	AS SHOWN	A. FISCHER
of\0						DRAWN:
					ROFILE VERT.	A. FISCHER
Projects∖Roseburg,						CHECKED:
Ros						R. VOORHIES
jects				ONE IN	ICH (REF)	CWE PROJECT NO.
Pro						40193 023 01

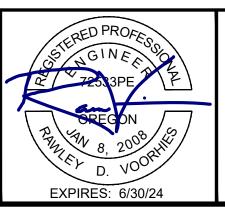



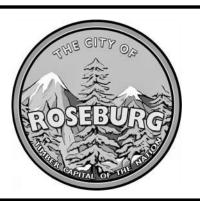

900 SE DOUGLAS AVE. **ROSEBURG, OR 97470** 

CITY PROJECT #: 23PW01 **CITY PROJECT MANAGER** RICK CASTLE

#### **GENERAL NOTES**

G-03

SHEET NO.

STEWART PARKWAY & PINE STREET PAVEMENT IMPROVEMENTS **APRIL 2023** 


#### **GENERAL NOTES:**

- 1. APPLY LANE CLOSURES DURING PAVING OPERATIONS PER ODOT STANDARD DRAWING TM850, OR APPROVED TRAFFIC CONTROL PLAN.
- 2. TACK COAT ALL ACP SURFACES TO RECEIVE NEW ACP.
- 3. REPLACE ALL STRIPING AND REFLECTORS IN PLACE, UNLESS OTHERWISE NOTED. SEE STRIPING AND SIGNING NOTES, SHEET G-03.
- 4. FOR WORK HOURS AND ALLOWABLE LANE CLOSURES, SEE TRAFFIC CONTROL PLANS.

#### LEGEND:



LIMITS OF AC PAVING AND COLD PLANE PAVEMENT REMOVAL. SEE TYPICAL SECTIONS, SHEET D-01

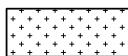

LIMITS OF 20" ASPHALT CONCRETE PAVEMENT REPAIR. SEE DETAIL 1, SHEET D-03


STRIPING MODIFICATION

# CONSTRUCTION KEYED NOTES:


- 1 INSTALL INLET PROTECTION TYPE 3, SEE ODOT STANDARD DRAWING RD1010.
- 6 MATCH EXISTING GRADE, SEE DETAILS 2 & 3 ON SHEET D-02.
- 8 PRESERVE AND PROTECT IN PLACE.
- 9 INSTALL STORM DRAIN MARKING STENCIL, SEE DETAIL 2 ON SHEET D-03.
- REMOVE AND REPLACE EXISTING 13.5" X 32" INLET GRATE WITH BICYCLE-SAFE GRATE.
- 12 INSTALL 8" WHITE LINE PER DETAIL W-2 ON OREGON STANDARD DRAWING TM500.
- 13 INSTALL BICYCLE LANE STENCIL PER DETAIL BS ON OREGON STANDARD DRAWING TM503.
- CONTRACTOR SHALL PRUNE TREE TO PROVIDE CLEARANCE FOR VEHICLES ROUTED ADJACENT TO CURB LINE, SEE TRAFFIC CONTROL PLANS FOR VEHICLE ROUTING.

0_	20	4
	SCALE OF FEET	
	SCALE: 1"=20'	

NO.	DATE	BY	REVISION	SCALE		DESIGNED:
				PLAN PROFILE	AS SHOWN	A. FISCHER
						DRAWN:
					OFILE VERT.	A. FISCHER
						CHECKED:
						R. VOORHIES
				ONE INCH (REF)		CWE PROJECT NO.
						40103 023 01

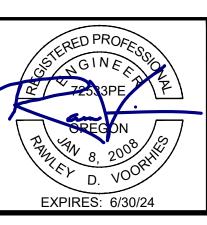



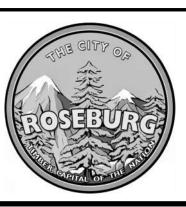

900 SE DOUGLAS AVE. ROSEBURG, OR 97470

CITY PROJECT #: 23PW01
CITY PROJECT MANAGER
RICK CASTLE

# PINE STREET IMPROVEMENTS PLAN STA 1+00 TO STA 6+00

STEWART PARKWAY & PINE STREET PAVEMENT IMPROVEMENTS
APRIL 2023

4 OF 13


SHEET NO.

C-01

#### **GENERAL NOTES:**

- 1. APPLY LANE CLOSURES DURING PAVING OPERATIONS PER ODOT STANDARD DRAWING TM850, OR APPROVED TRAFFIC CONTROL PLAN.
- 2. TACK COAT ALL ACP SURFACES TO RECEIVE NEW ACP.
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- 4. FOR WORK HOURS AND ALLOWABLE LANE CLOSURES, SEE TRAFFIC CONTROL PLANS.

#### LEGEND:

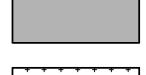

LIMITS OF AC PAVING AND COLD PLANE PAVEMENT REMOVAL. SEE TYPICAL SECTIONS, SHEET D-01



LIMITS OF 20" ASPHALT CONCRETE PAVEMENT REPAIR. SEE DETAIL 1, SHEET D-03


STRIPING MODIFICATION

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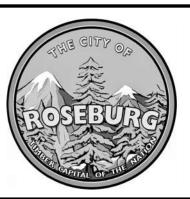
- 1 INSTALL INLET PROTECTION TYPE 3, SEE ODOT STANDARD DRAWING RD1010.
- 3 INSTALL INLET PROTECTION TYPE 11, SEE ODOT STANDARD DRAWING RD1010.
- 6 MATCH EXISTING GRADE, SEE DETAILS 2 & 3 ON SHEET D-02.
- $\langle 8 \rangle$  PRESERVE AND PROTECT IN PLACE.
- 9 INSTALL STORM DRAIN MARKING STENCIL, SEE DETAIL 2 ON SHEET D-03.
- 12 INSTALL 8" WHITE LINE PER DETAIL W-2 ON OREGON STANDARD DRAWING TM500.
- 13 INSTALL BICYCLE LANE STENCIL PER DETAIL BS ON OREGON STANDARD DRAWING TM503.

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SCALE OF FEET								
	SCALE: 1"=20'							

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900 SE DOUGLAS AVE.
ROSEBURG, OR 97470
CITY PROJECT #: 23PW01

CITY PROJECT #: 23PW01
CITY PROJECT MANAGER
RICK CASTLE
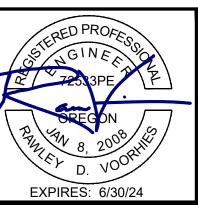
# PINE STREET IMPROVEMENTS PLAN STA 6+00 TO STA 10+60

STEWART PARKWAY & PINE STREET PAVEMENT IMPROVEMENTS
APRIL 2023

5 OF 13

SHEET NO.

C-02

4/10/2023 3:19 PM Anthony Fisc

RKING/C-01 to C-04 dwg 4/10/2023 3:19 PM

| 2021 Design\CAD\\_WORKING\C-01 to C-04.dwg

#### **GENERAL NOTES:**

- 1. APPLY LANE CLOSURES DURING PAVING OPERATIONS PER ODOT STANDARD DRAWING TM850, OR APPROVED TRAFFIC CONTROL PLAN.
- 2. TACK COAT ALL ACP SURFACES TO RECEIVE NEW ACP.
- 3. REPLACE ALL STRIPING AND REFLECTORS IN PLACE, UNLESS OTHERWISE NOTED. SEE STRIPING AND SIGNING NOTES, SHEET G-03.
- 4. ALL WORK ON NW STEWART PARKWAY SHALL BE PERFORMED AT NIGHT BETWEEN THE HOURS OF 7:00 PM AND 6:00 AM. UP TO 5 NIGHTS OF FULL CLOSURES ARE ALLOWED. IF A FULL CLOSURE IS NOT BEING IMPLEMENTED, CONTRACTOR SHALL MAINTAIN 1 LANE OF TRAFFIC MINIMUM IN EACH DIRECTION DURING CONSTRUCTION ACTIVITIES.

#### LEGEND:

LIMITS OF AC PAVING AND COLD PLANE PAVEMENT REMOVAL. SEE TYPICAL SECTION, SHEET D-01

1 > INSTALL INLET PROTECTION TYPE 3, SEE ODOT STANDARD DRAWING RD1010.

**CONSTRUCTION KEYED NOTES:** 

- $\langle 2 \rangle$  INSTALL INLET PROTECTION TYPE 10, SEE ODOT STANDARD DRAWING RD1010.
- 6 MATCH EXISTING GRADE, SEE DETAILS 2 & 3 ON SHEET D-02.
- $\langle$  8  $\rangle$  PRESERVE AND PROTECT IN PLACE.
- $\langle 9 \rangle$  INSTALL STORM DRAIN MARKING STENCIL, SEE DETAIL 2 ON SHEET D-03.
- $\langle 10 \rangle$  REMOVE EXISTING INDUCTION LOOP, INSTALL NEW 6' DIA ROUND INDUCTION LOOP PER ODOT STANDARD DRAWINGS TM475 & TM480 ON SHEET D-03.
  - INSTALL DETECTOR IN LOCATION SHOWN OR AS DIRECTED BY THE CITY, PRIOR TO INSTALLATION OF PERMANENT PAVEMENT MARKINGS.
- $\langle 11 \rangle$  Install bi-directional blue type 1ar marker IN-LINE WITH EXISTING FIRE HYDRANT.

- $\langle 12 \rangle$  INSTALL 8" WHITE LINE PER DETAIL W-2 ON OREGON STANDARD DRAWING TM500.
- INSTALL BICYCLE LANE STENCIL PER DETAIL BS ON OREGON STANDARD DRAWING TM503.
- INSTALL MODIFIED 4" NARROW DOUBLE YELLOW LINES WITH REFLECTORS, REFLECTORS CENTERED UPON YELLOW LINES, SEE DETAIL ND/R-40 ON OREGON STANDARD DRAWING TM502.
- $\langle 15 \rangle$ INSTALL WHITE STRAIGHT ARROW PER DETAIL SA ON OREGON STANDARD DRAWING TM501.
- $\langle 16 \rangle$  INSTALL WHITE LEFT TURN ARROW PER DETAIL LA ON OREGON STANDARD DRAWING TM501.
- $\langle 17 \rangle$  INSTALL WHITE LEFT TURN STRAIGHT ARROW PER DETAIL LSA ON OREGON STANDARD DRAWING TM501.

INSTALL CHANNELIZING LINE POSITIONING GUIDE REFLECTORS WITH 8" WHITE LINE PER W-2/R-20L ON OREGON STANDARD DRAWING TM502.



SCALE OF FEET

# SCALE: 1"=20'

SHEET NO. STEWART PARKWAY IMPROVEMENTS PLAN


C-03

6 OF 13


STEWART PARKWAY & PINE STREET PAVEMENT IMPROVEMENTS **APRIL 2023** 

STA 1+00 TO STA 6+00

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						40402 022 04

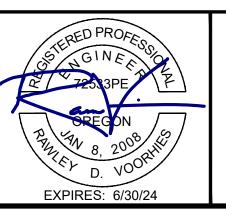



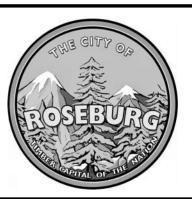

900 SE DOUGLAS AVE. **ROSEBURG, OR 97470** 

CITY PROJECT #: 23PW01 **CITY PROJECT MANAGER** RICK CASTLE

#### **GENERAL NOTES:**

- 1. APPLY LANE CLOSURES DURING PAVING OPERATIONS PER ODOT STANDARD DRAWING TM850, OR APPROVED TRAFFIC CONTROL PLAN.
- 2. TACK COAT ALL ACP SURFACES TO RECEIVE NEW ACP.
- 3. REPLACE ALL STRIPING AND REFLECTORS IN PLACE, UNLESS OTHERWISE NOTED. SEE STRIPING AND SIGNING NOTES, SHEET G-03.
- 4. ALL WORK ON NW STEWART PARKWAY SHALL BE PERFORMED AT NIGHT BETWEEN THE HOURS OF 7:00 PM AND 6:00 AM. UP TO 5 NIGHTS OF FULL CLOSURES ARE ALLOWED. IF A FULL CLOSURE IS NOT BEING IMPLEMENTED, CONTRACTOR SHALL MAINTAIN 1 LANE OF TRAFFIC MINIMUM IN EACH DIRECTION DURING CONSTRUCTION ACTIVITIES.

#### LEGEND:

LIMITS OF AC PAVING AND COLD PLANE PAVEMENT REMOVAL. SEE TYPICAL SECTION, SHEET D-01

# CONSTRUCTION KEYED NOTES:

- 2 INSTALL INLET PROTECTION TYPE 10, SEE ODOT STANDARD DRAWING RD1010.
- LOWER EXISTING MANHOLE BELOW THE PROPOSED PAVING DEPTH PRIOR TO COLD PLANE PAVEMENT REMOVAL. ADJUST EXISTING STORM SEWER MANHOLE TO FINISH GRADE FOLLOWING PAVING OPERATIONS.
  - SEE DETAIL 1 ON SHEET D-02
- 6 MATCH EXISTING GRADE, SEE DETAILS 2 & 3 ON SHEET D-02.
- $\overline{\left\langle 8\right\rangle }$  PRESERVE AND PROTECT IN PLACE.
- 9 INSTALL STORM DRAIN MARKING STENCIL, SEE DETAIL 2 ON SHEET D-03.
- REMOVE EXISTING INDUCTION LOOP,
  INSTALL NEW 6' DIA ROUND INDUCTION LOOP PER
  ODOT STANDARD DRAWINGS TM475 & TM480 ON
  SHEET D-03.
  INSTALL DETECTOR IN LOCATION SHOWN OR AS
  DIRECTED BY THE CITY, PRIOR TO INSTALLATION


OF PERMANENT PAVEMENT MARKINGS.

- 12 INSTALL 8" WHITE LINE PER DETAIL W-2 ON OREGON STANDARD DRAWING TM500.
- 13 INSTALL BICYCLE LANE STENCIL PER DETAIL BS ON OREGON STANDARD DRAWING TM503.
- INSTALL MODIFIED 4" NARROW DOUBLE YELLOW LINES WITH REFLECTORS,
  REFLECTORS CENTERED UPON YELLOW LINES,
  SEE DETAIL ND/R-40 ON OREGON STANDARD DRAWING TM502.
- 15 INSTALL WHITE STRAIGHT ARROW PER DETAIL SA ON OREGON STANDARD DRAWING TM501.
- (16) INSTALL WHITE LEFT TURN ARROW PER DETAIL LA ON OREGON STANDARD DRAWING TM501.
- 18 INSTALL WHITE RIGHT TURN ARROW PER DETAIL RA ON OREGON STANDARD DRAWING TM501.
- 19 INSTALL WHITE BROKEN LINE WITH REFLECTORS PER DETAIL WB/R-40 ON OREGON STANDARD DRAWING TM502.


- 20 INSTALL 1' WHITE STANDARD CROSSWALK BAR PER DETAIL S ON OREGON STANDARD DRAWING TM503.
- 21 INSTALL 8" WHITE DOTTED LINE PER DETAIL WD-2 ON OREGON STANDARD DRAWING TM500.
- 23 INSTALL CHANNELIZING LINE POSITIONING GUIDE REFLECTORS WITH 8" WHITE LINE PER W-2/R-20L ON OREGON STANDARD DRAWING TM502.

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SCALE OF FEET							
SCALE: 1"=20'							

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900 SE DOUGLAS AVE. ROSEBURG, OR 97470

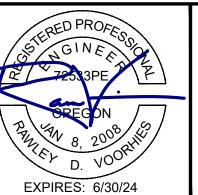CITY PROJECT #: 23PW01
CITY PROJECT MANAGER
RICK CASTLE


# STEWART PARKWAY IMPROVEMENTS PLAN STA 6+00 TO STA 10+00

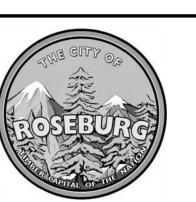C-04

STEWART PARKWAY & PINE STREET PAVEMENT IMPROVEMENTS
APRIL 2023

7 OF 13

SHEET NO.

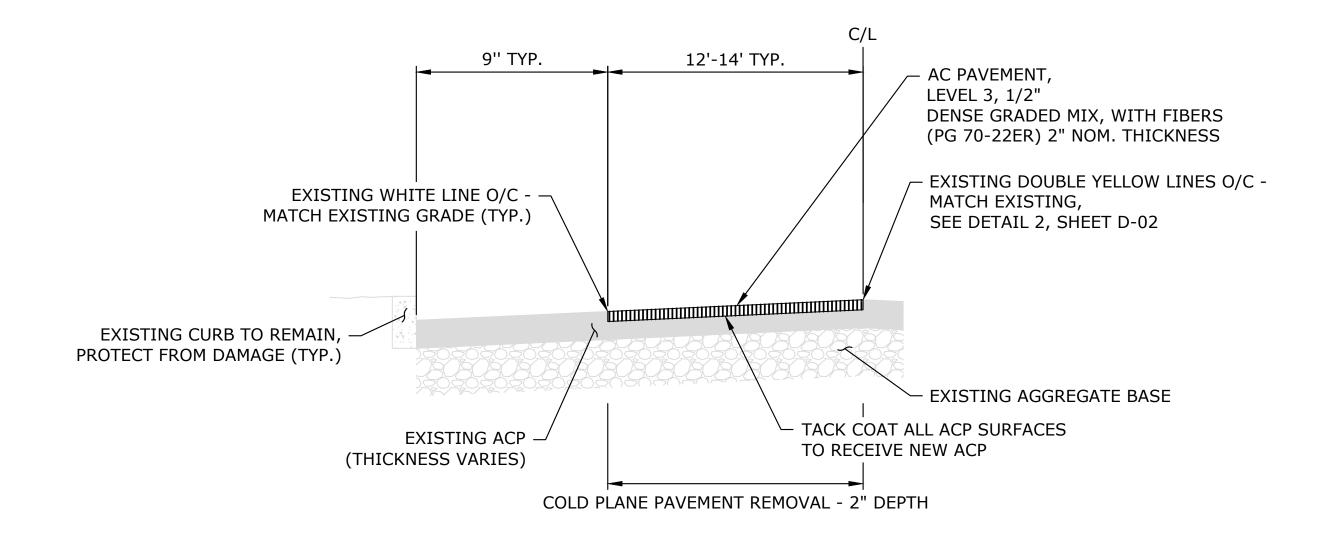


18'-30' TYP. AC PAVEMENT, -LEVEL 3, 1/2" DENSE GRADED MIX, WITH FIBERS (PG 70-22ER) 2" NOM. THICKNESS - EXISTING DOUBLE YELLOW LINES O/C -EXISTING CURB TO REMAIN, -MATCH EXISTING, PROTECT FROM DAMAGE (TYP.) SEE DETAIL 2, SHEET D-02 MATCH EXISTING GRADE TACK COAT ALL ACP SURFACES EXISTING ACP -TO RECEIVE NEW ACP EXISTING AGGREGATE BASE (THICKNESS VARIES) COLD PLANE PAVEMENT REMOVAL - 2" DEPTH


PINE STREET-SB HWY 99 TYPICAL SECTION - STA 1+20 TO STA 2+35

D-01

PINE STREET-SB HWY 99 TYPICAL SECTION - STA 2+35 TO STA 4+10



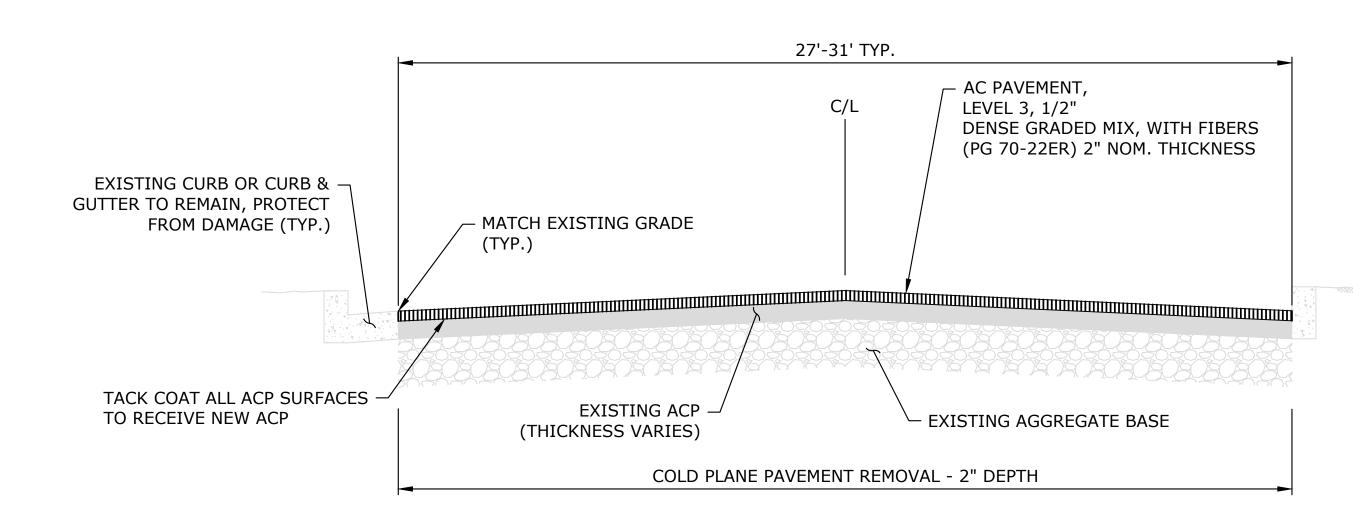

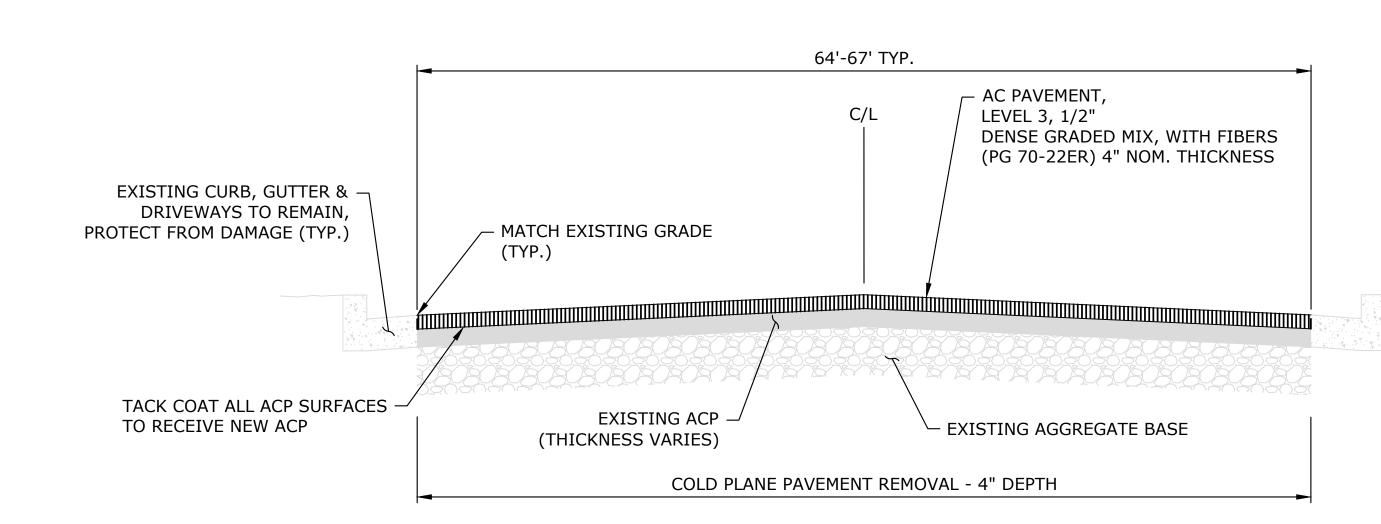

PINE STREET TYPICAL SECTION - STA 4+10 TO STA 10+31




STEWART PARKWAY TYPICAL SECTION




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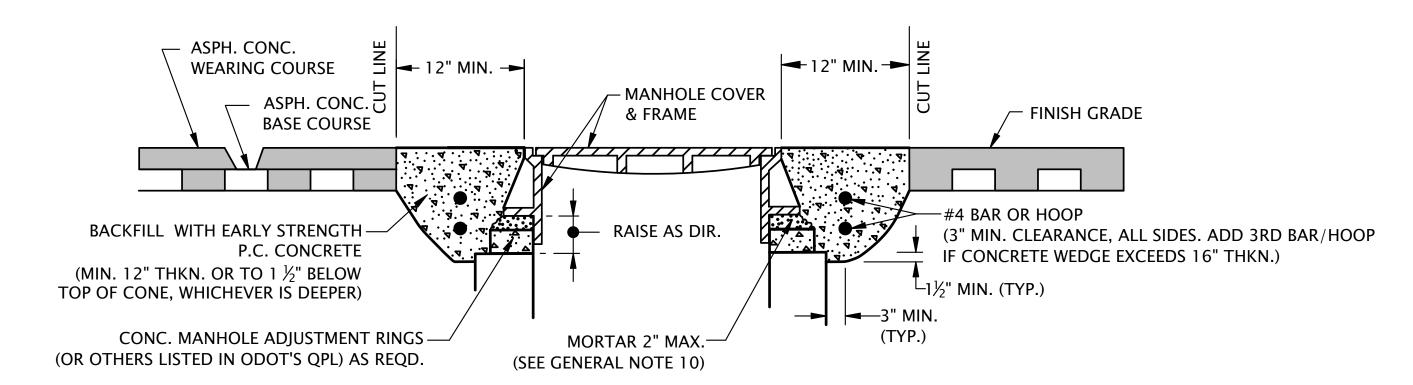
900 SE DOUGLAS AVE. **ROSEBURG, OR 97470** CITY PROJECT #: 23PW01 **CITY PROJECT MANAGER RICK CASTLE** 

**DETAILS** 

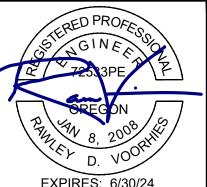**APRIL 2023** 


D-01 STEWART PARKWAY & PINE STREET PAVEMENT IMPROVEMENTS

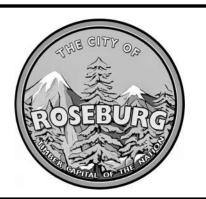METHOD "A" - SQUARE OR CIRCULAR CUT



METHOD "B" - CIRCULAR CUT ONLY


# MANHOLE FRAME ADJUSTMENT

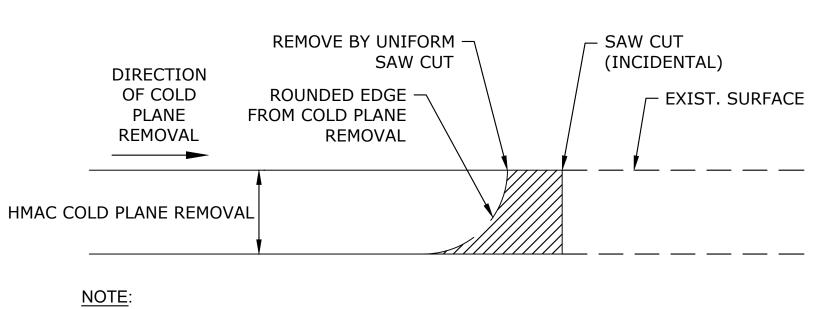

WHEN COLD PLANE REMOVAL PRODUCES A ROUNDED EDGE, A SAW CUT SHALL BE USED TO MANUFACTURE A PERPENDICULAR EDGE AS SHOWN. THE ENGINEER SHALL BE SOLE JUDGE CONCERNING THE USE OF THIS DETAIL.


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ACP DETAIL AT BUTT JOINT SCALE: NTS

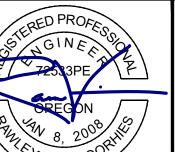

 $\begin{pmatrix} 2 \\ D-02 \end{pmatrix}$ 



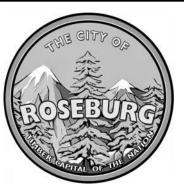

900 SE DOUGLAS AVE. **ROSEBURG, OR 97470** 

**RICK CASTLE** 

# **DETAILS**

**APRIL 2023** 

STEWART PARKWAY & PINE STREET PAVEMENT IMPROVEMENTS

**D-02** 

SHEET NO.

(3" MIN CLEARANCE, ALL SIDES. ADD 3RD BAR/HOOP

**PLAN SQUARE CUT** 

# CIRCULAR CUT

MANHOLE COVER &

FRAME

#4 HOOP - 2 EACH


- CUT LINE


#### MANHOLE FRAME ADJUSTMENT NOTES:

#4 BAR

- 2 EACH

- 1. COVER MANHOLE WITH BUILDING PAPER AND CONSTRUCT ASPHALT CONCRETE BASE COURSE AND WEARING COURSES.
- 2. SAW CUT SQUARE OR CIRCULAR EXCAVATION AROUND MANHOLE 12" MIN. FROM
- RAISE MANHOLE COVER AND FRAME TO FINISH GRADE BY INSTALLING CONCRETE MANHOLE ADJUSTMENT RINGS
- AND LEVELING MORTAR, AS SHOWN. 4. BACKFILL WITH 5,000 PSI EARLY STRENGTH PORTLAND CEMENT CONCRETE. ALL
- CONCRETE SHALL BE COMMERCIAL GRADE CONCRETE. 5. PROTECT FROM TRAFFIC LOADING UNTIL CONC. HAS CURED TO 3000 PSI.
- APPLY TACK COAT TO EDGES OF EXISTING PAVEMENT BEFORE INSTALLING PATCH.
- FINISH JOINT WITH ASPHALT SEAL AND SAND.
- SEE STD. DWG. RD336 FOR MANHOLE STEPS DETAILS.
- SEE APPROPRIATE MANHOLE STANDARD DRAWINGS FOR DETAILS NOT SHOWN.
- 10. USE EPOXY FOR SYNTHETIC GRADE RINGS.
- 11. SEE STD. DWG. RD336 FOR TRACER WIRE DETAILS.
- 12. SEE STD. DWG. RD356 FOR MANHOLE COVERS AND FRAMES.

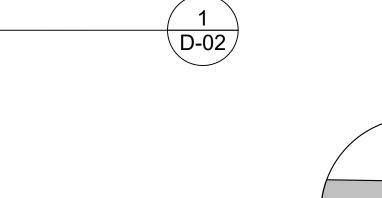

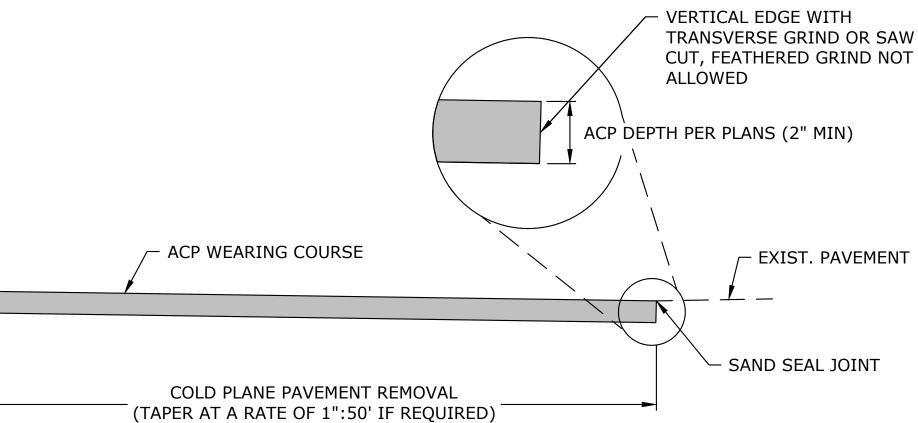

AC PAVEMENT MATCH AT PROJECT ENDS SCALE: NTS

3
D-02

- CUT LINE

PLAN

**→**12" MIN. →

MANHOLE COVER &


FRAME

SCALE DESIGNED: DATE REVISION BY A. FISCHER AS SHOWN DRAWN: HORIZ. A. FISCHER **PROFILE** CHECKED: VERT. R. VOORHIES ONE INCH (REF) CWE PROJECT NO.

EXPIRES: 6/30/24


5500 MEADOWS RD. #250 | LAKE OSWEGO, OR 97035 | WWW.CENTURYWEST.COM | 503.419.2130

CITY PROJECT #: 23PW01 **CITY PROJECT MANAGER** 

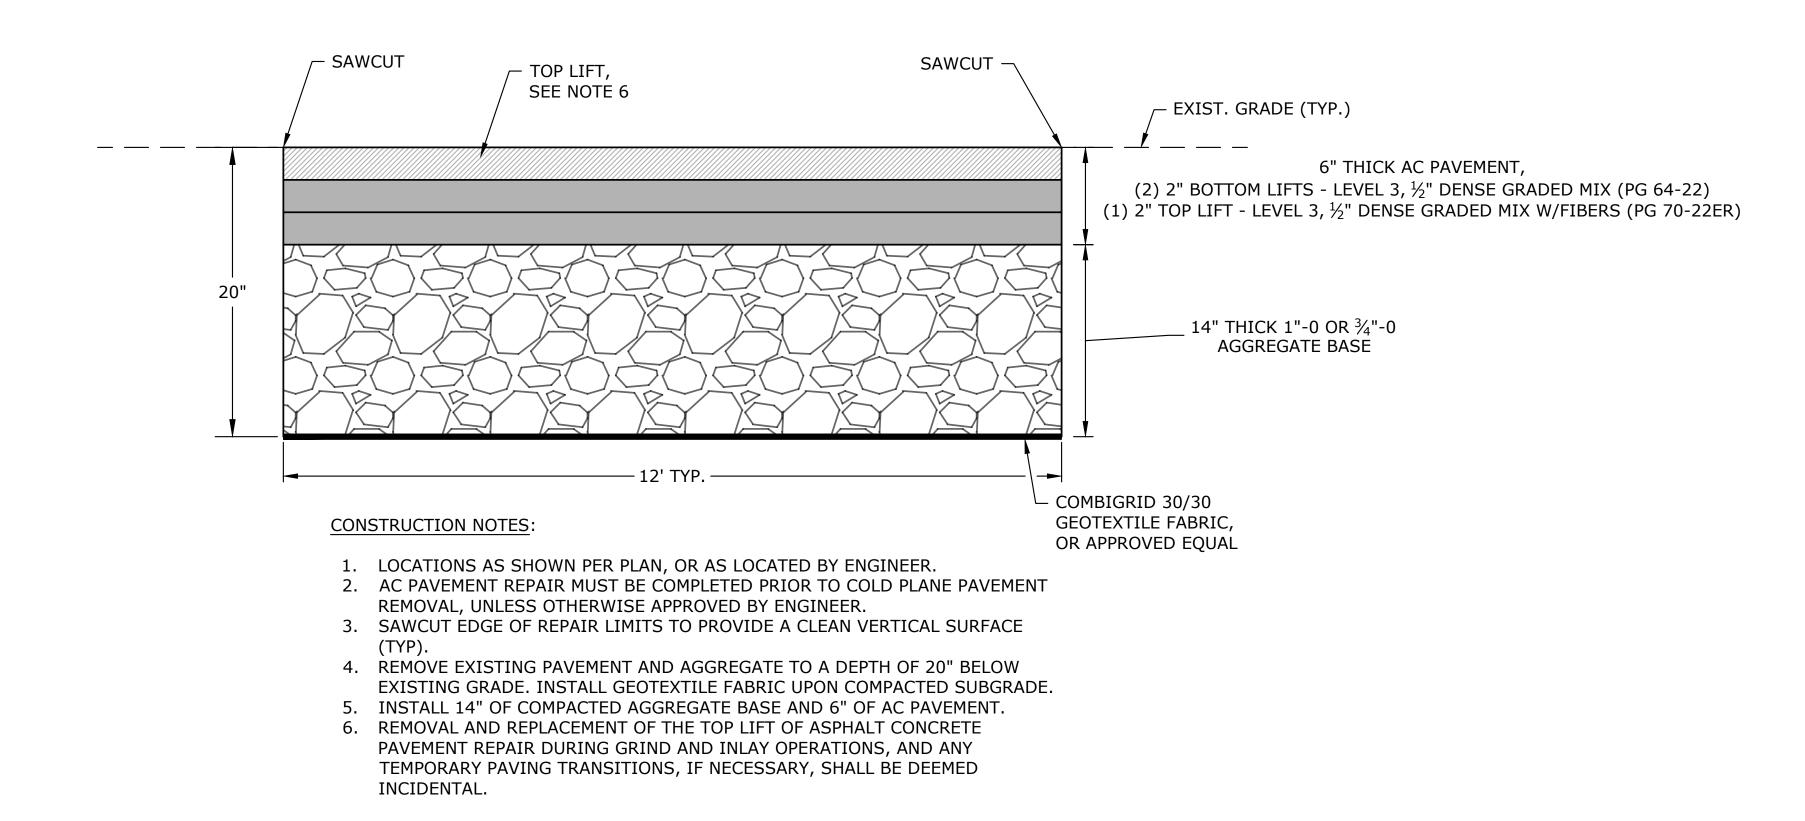

20" ASPHALT CONCRETE PAVEMENT REPAIR
SCALE: NTS



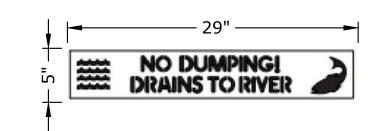

NOTE:

PLACE INLET STENCIL ON THE TOP OF THE CURB OR CONCRETE INLET AS DIRECTED. PREPARE AND CLEAN SURFACE PRIOR TO PLACEMENT IN ACCORDANCE WITH SECTION 00850.43 OF THE STANDARD SPECIFICATIONS.

STORM DRAIN MARKING STENCIL (BLUE/WHITE)


STORM DRAIN MARKING STENCIL
SCALE: NTS



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900 SE DOUGLAS AVE. ROSEBURG, OR 97470


CITY PROJECT #: 23PW01
CITY PROJECT MANAGER
RICK CASTLE

# **DETAILS**

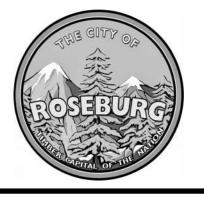
D-03

SHEET NO.

STEWART PARKWAY & PINE STREET PAVEMENT IMPROVEMENTS
APRIL 2023

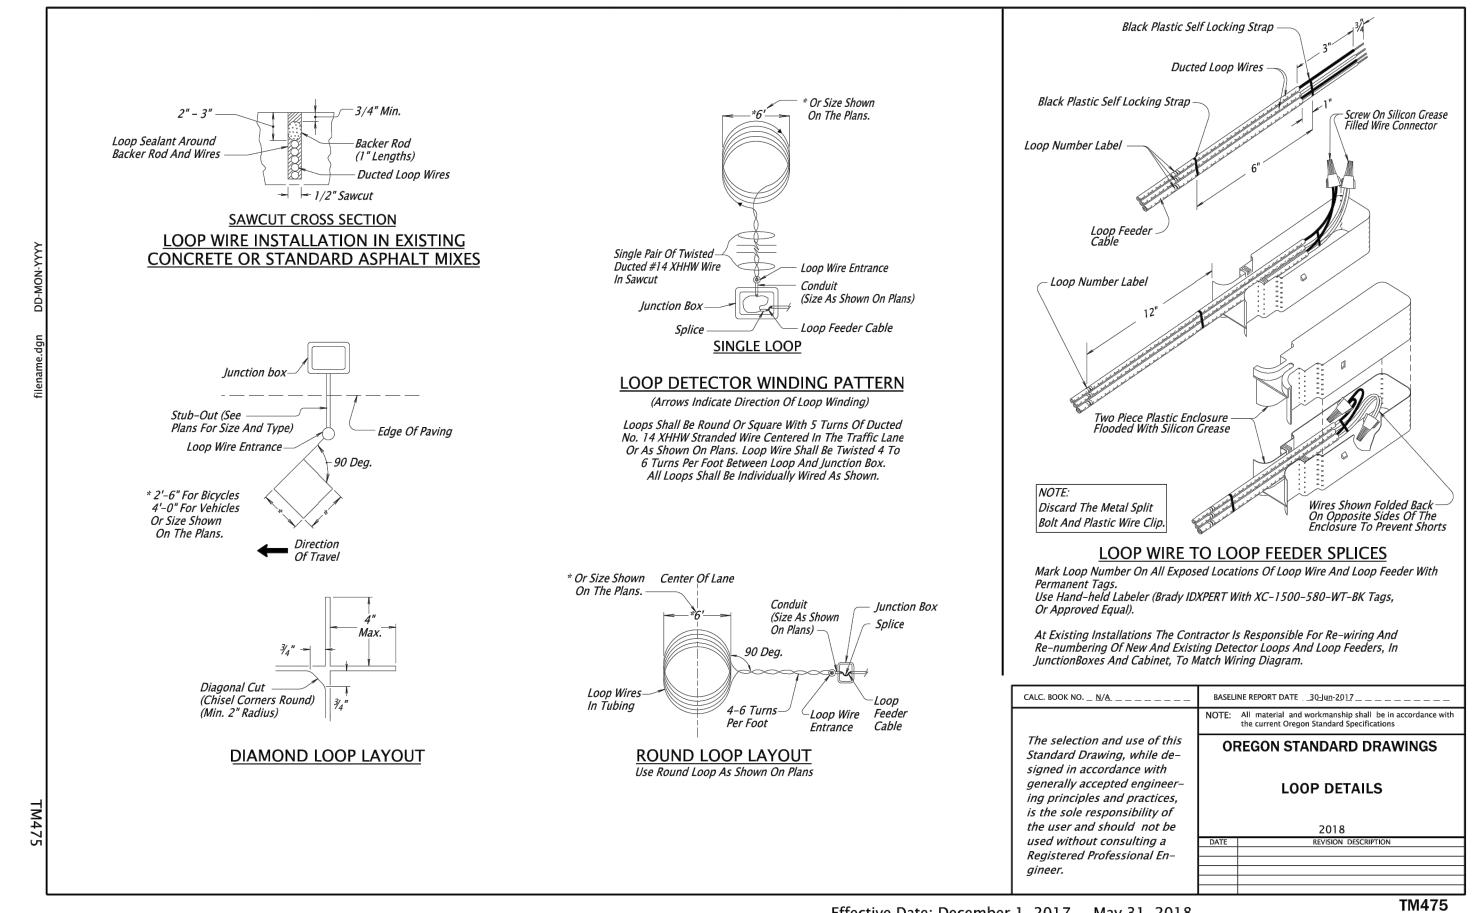


Effective Date: December 1, 2017 - May 31, 2018

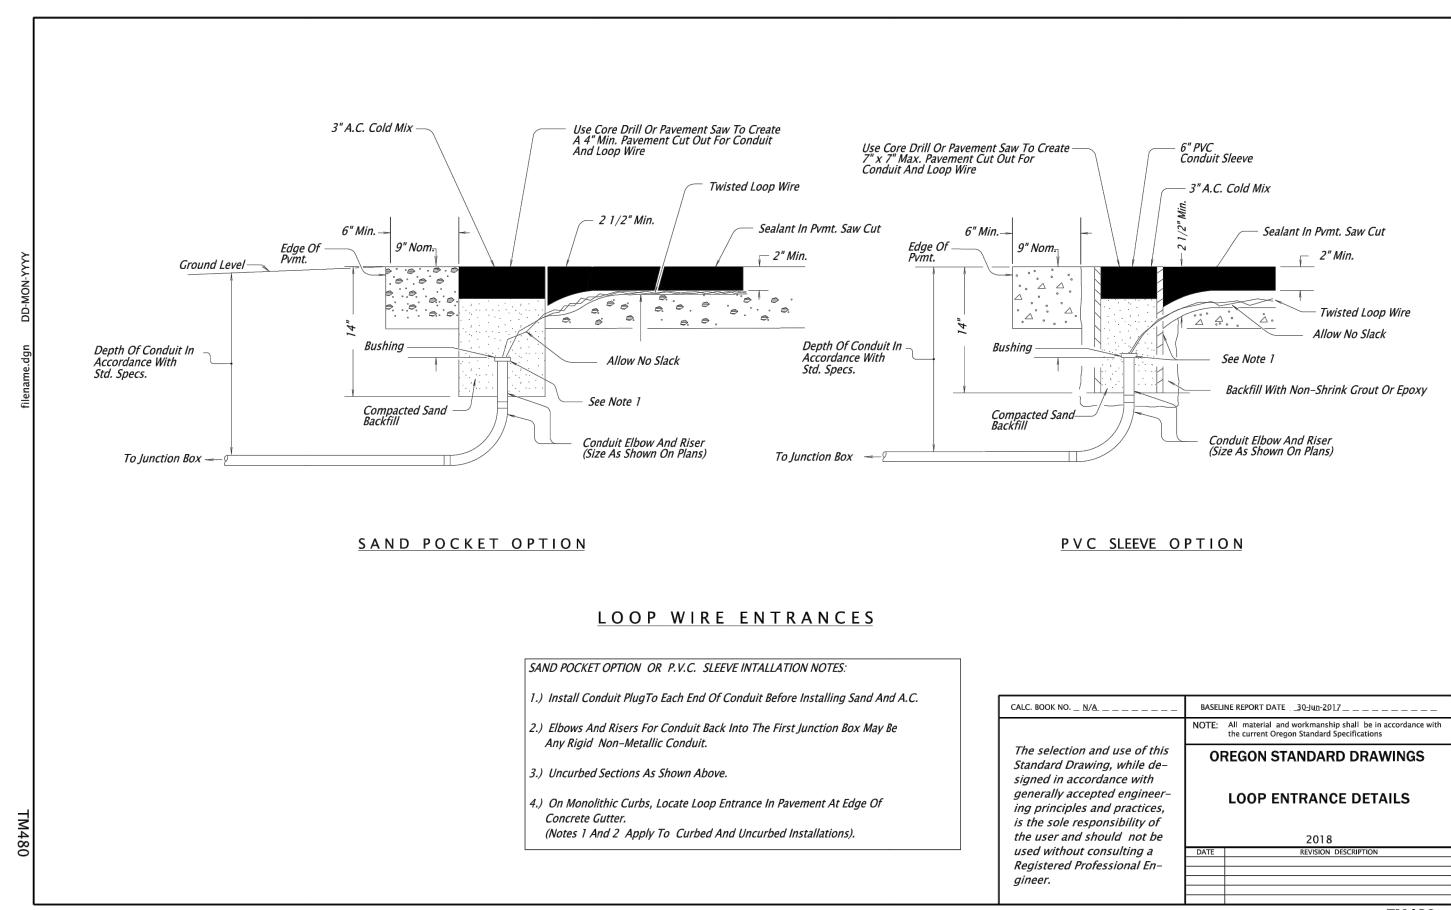


Effective Date: December 1, 2017 - May 31, 2018

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900 SE DOUGLAS AVE. **ROSEBURG, OR 97470** CITY PROJECT #: 23PW01 **CITY PROJECT MANAGER** 

**RICK CASTLE** 
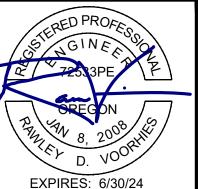
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**D-04** 

STEWART PARKWAY & PINE STREET PAVEMENT IMPROVEMENTS **APRIL 2023** 

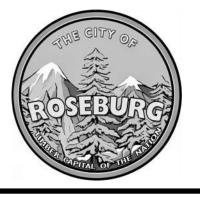11 OF 13

SHEET NO.

TRAFFIC CONTROL PLAN (NIGHT)

SCALE: 1"=40'

 NO LEFT TURNS FROM SE STEPHENS ST TO SE RICE ST SHALL BE PERMITTED. CONTRACTOR TO SIGN ACCORDINGLY

## TRAFFIC CONTROL NOTES (NIGHT):

- 1. ALL WORK IS NIGHT WORK AND SHALL BE PERFORMED BETWEEN THE HOURS OF 7:00 PM AND 6:00 AM.
- FULL CLOSURES OF SE PINE ST SOUTH OF SE RICE ST ARE PERMITTED DURING NIGHT WORK HOURS ONLY AND SHALL BE LIMITED TO A MAXIMUM OF 14 CALENDAR DAYS.
- 3. ONE LANE OF TRAFFIC SHALL BE MAINTAINED IN BOTH THE SOUTHBOUND AND NORTHBOUND DIRECTION AT ALL TIMES.
- 4. SEE OREGON TEMPORARY TRAFFIC CONTROL PLANS (TM800 SERIES) FOR TEMPORARY SIGNAGE REQUIREMENTS.
- 5. BIKE LANE ON SOUTHBOUND SE PINE ST SHALL BE CLOSED WITHIN WORK LIMITS WHEN THIS TRAFFIC CONTROL PLAN IS IN PLACE. PROVIDE BIKES TO SHARE ROADWAY AND OTHER APPROPRIATE SIGNAGE.

#### LEGEND:


- BARRICADE (TYPE III),
  SEE OREGON STD. DWG. TM820
- • PLASTIC DRUMS, 10' SPACING
- • TUBULAR MARKER (28"), 10' SPACING
- TRAFFIC DIRECTION ARROW

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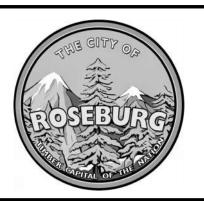
SCALE OF FEET

SCALE: 1"=40'

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900 SE DOUGLAS AVE. ROSEBURG, OR 97470

CITY PROJECT #: 23PW01
CITY PROJECT MANAGER
RICK CASTLE
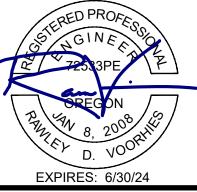
# TRAFFIC CONTROL PLAN - PINE ST (NIGHT)

TC-01

SHEET NO.

STEWART PARKWAY & PINE STREET PAVEMENT IMPROVEMENTS
APRIL 2023

### TRAFFIC CONTROL PLAN (DAY)

SCALE: 1"=40'

# TRAFFIC CONTROL NOTES (DAY):

- 1. WORK IS NOT PERMITTED BETWEEN THE HOURS OF 6:00 AM AND 7:00 PM.
- 2. ONE LANE OF SOUTHBOUND TRAFFIC SHALL BE MAINTAINED ON SE PINE ST AT ALL TIMES.
- 3. BETWEEN THE HOURS OFF 6:00 AM AND 7:00 PM, MONDAY THRU FRIDAY, THE MAXIMUM ALLOWABLE PAVEMENT EDGE DROP OFF SHALL BE 6". DURING WEEKENDS, OR IF CONTINUOUS NIGHT CONSTRUCTION OPERATIONS CEASE FOR MORE THAN TWO (2) CONSECUTIVE DAYS, THE MAXIMUM ALLOWABLE PAVEMENT EDGE DROP OFF SHALL BE 2"
- 4. SEE OREGON TEMPORARY TRAFFIC CONTROL PLANS (TM800 SERIES) FOR TEMPORARY SIGNAGE REQUIREMENTS.
- 5. BIKE LANE ON SOUTHBOUND SE PINE ST SHALL BE CLOSED WITHIN WORK LIMITS WHEN THIS TRAFFIC CONTROL PLAN IS IN PLACE. PROVIDE BIKES TO SHARE ROADWAY AND OTHER APPROPRIATE SIGNAGE.

#### LEGEND:


- BARRICADE (TYPE III),
  SEE OREGON STD. DWG. TM820
- • PLASTIC DRUMS, 10' SPACING
- • TUBULAR MARKER (28"), 10' SPACING
- TRAFFIC DIRECTION ARROW

40 80


SCALE OF FEET

SCALE: 1"=40'

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				PROFILE	VERT.	CHECKED:
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900 SE DOUGLAS AVE. ROSEBURG, OR 97470

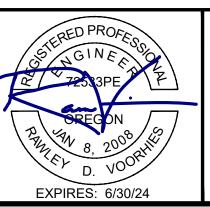CITY PROJECT #: 23PW01
CITY PROJECT MANAGER
RICK CASTLE

# TRAFFIC CONTROL PLAN - PINE ST (DAY)

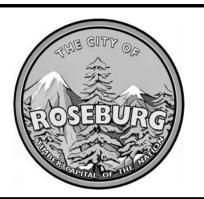TC-02

SHEET NO.

STEWART PARKWAY & PINE STREET PAVEMENT IMPROVEMENTS
APRIL 2023