

STEPHENS STREET PAVEMENT IMPROVEMENTS PROJECT NO. 22PW01 PH 2

MAY 2022

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DETAILS


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5500 MEADOWS RD. #250LAKE OSWEGO, OR 97035WWW.CENTURYWEST.COM503.419.2130



STANDARD DRAWINGS LIST

ODOT STAND	ARD DRAWINGS:
RD115	MONUMENT BOX
RD258	VALVE BOX & OPERATOR EXTENSION ASSEMBLY
RD376	MISCELLANEOUS DRAINAGE STRUCTURES SIPHON BOX, INLET CAP & INLET ADJUSTMENT
RD706	TRAFFIC SEPARATORS AND TRANSITIONS
RD1010	INLET PROTECTION TYPE 2, 3, 6, 7, 10 AND 11
TM475	LOOP DETAILS
TM480	LOOP ENTRANCE DETAILS
TM500	PAVEMENT MARKING STANDARD DETAIL BLOCKS
TM501	PAVEMENT MARKING STANDARD DETAIL BLOCKS
TM502	PAVEMENT MARKING STANDARD DETAIL BLOCKS
TM503	PAVEMENT MARKING STANDARD DETAIL BLOCKS
TM530	INTERSECTION PAVEMENT MARKINGS (CROSSWALK, STOP BAR & BIKE LANE STENCIL)
TM800	TABLES, ABRUPT EDGE AND PCMS DETAILS
TM810	TEMPORARY PAVEMENT MARKING
TM820	TEMPORARY BARRICADES
TM821	TEMPORARY SIGN SUPPORTS
TM840	CLOSURE DETAILS
TM841	INTERSECTION WORK ZONE DETAILS
TM842	SIGNALIZED INTERSECTION DETAILS
TM843	MULTI-LANE SIGNALIZED INTERSECTION DETAILS
TM844	TEMPORARY PEDESTRIAN ACCESSIBLE ROUTES
TM850	2-LANE, 2-WAY ROADWAYS
TM851	NON-FREEWAY MULTI-LANE SECTIONS
TM852	NON-FREEWAY MULTI-LANE SECTIONS

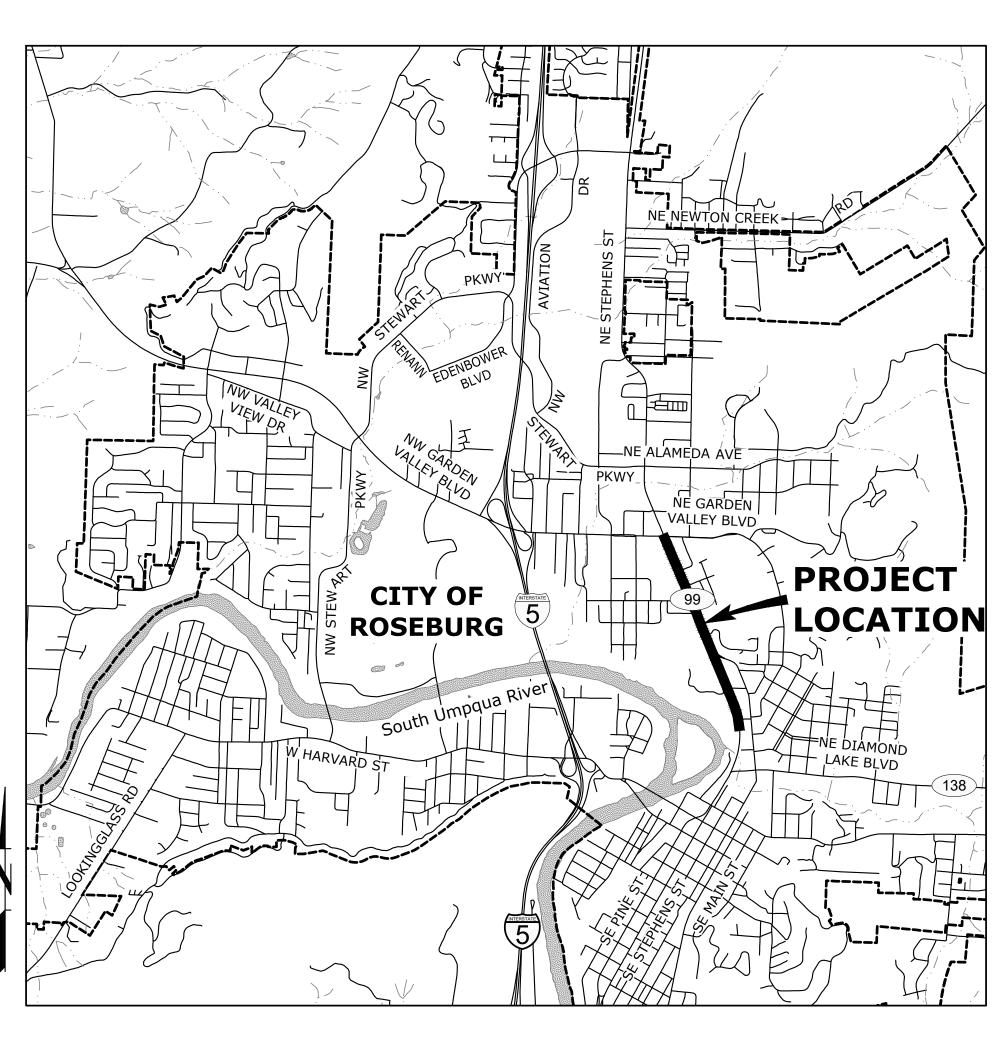


ATTENTION: OREGON LAW REQUIRES THE CONTRACTOR TO FOLLOW THE RULES ADOPTED BY THE OREGON UTILITY NOTIFICATION CENTER. THOSE RULES ARE SET FORTH IN OAR 952-001-0010 THROUGH OAR 952-001-0090. THE CONTRACTOR MAY OBTAIN COPIES OF THE RULES BY CALLING THE UTILITY NOTIFICATION CENTER. (NOTE: THE TELEPHONE NUMBER FOR THE OREGON UTILITY NOTIFICATION CENTER IS 503-246-6699.)

VICINITY MAP SCALE: 1"=2,000'

LEGEND

	EXISTING
BOLLARD	
COMMUNICATION MANHOLE	\odot
COMMUNICATION RISER	
ELECTRICAL JUNCTION BOX	
FIRE HYDRANT	œ
GAS VALVE	٥
GUY WIRE ANCHOR	¢
INDUCTION LOOP	\bigcirc
IRRIGATION BOX	
LIGHT POLE	*
PROPERTY CORNER	0
SANITARY SEWER CLEANOUT	0
SANITARY SEWER MANHOLE	\$
SIGN	<u> </u>
STORM SEWER INLET	
STORM SEWER MANHOLE	Ø
SURVEY MONUMENT	0
TRAFFIC SEPARATOR	
UTILITY POLE	0 0 0
WATER METER	8
WATER VALVE	Þ4
RIGHT-OF-WAY	
ASPHALT PAVEMENT	

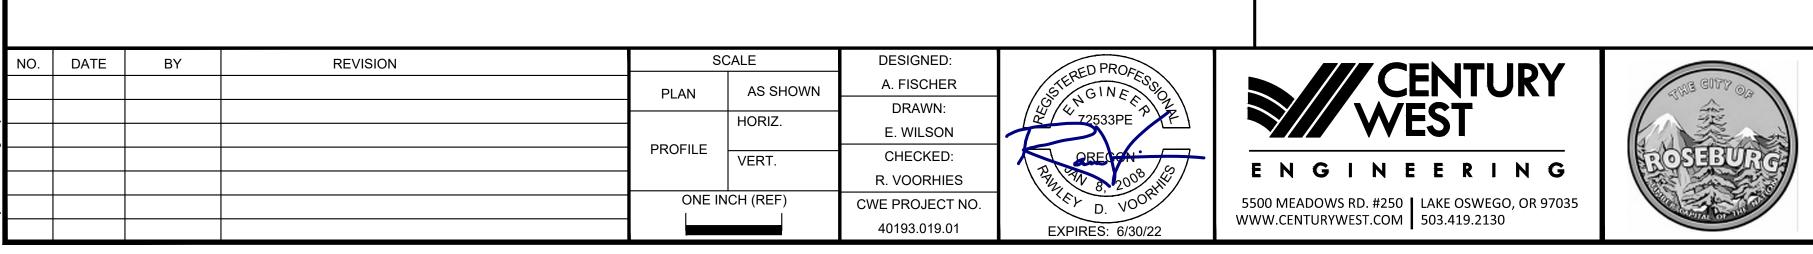

PROPOSED

ABBREVIATIONS

0	AT	HMAC	HOT MIX ASPHALT CONCRETE	SS	SANITARY SEWER
ABAN	ABANDON(ED)	HDPE	HIGH DENSITY POLYETHELENE	SSC	STAINLESS STEEL CLAMPS
С	ASPHALTIC CONCRETE	HORIZ	HORIZONTAL	SSCO	SANITARY SEWER CLEANOUT
СР	ASPHALTIC CONCRETE PAVEMENT	HWY	HIGHWAY	SSMH	SANITARY SEWER MANHOLE
DWF	AVERAGE DRY WEATHER FLOW	HP	HIGH PRESSURE	SST	STAINLESS STEEL
GG	AGGREGATE			ST	STREET
L	ALUMINUM	ID	IDENTIFICATION/INSIDE DIAMETER	STA	STATION
NSI	AMERICAN NATIONAL STANDARDS INSTITUTE	IE	INVERT ELEVATION	STD	STANDARD
APPROX		INSTL	INSTALL	STL	STEEL
	APPROVED	IR	IRON ROD	STPR	STORM POINT REPAIR
PWA	AMERICAN PUBLIC WORKS ASSOCIATION			S/W	SIDEWALK
SSY	ASSEMBLY	LAT LF			
ARV AWWA	AIR RELEASE VALVE AMERICAN WATER WORK ASSOCIATION		LINEAR FEET LANE	T/TEL TB	TELEPHONE THRUST BLOCK
(VV VVA	AMERICAN WATER WORK ASSOCIATION	LN LP	LANE LOW PRESSURE	TBD	TO BE DETERMINED
BFILL	BACKFILL	LP	LOW FRESSORE	TBM	TEMPORARY BENCH MARK
BLDG	BUILDING		LEFT	TCM	TRAFFIC CONTROL MEASURES
M	BENCHMARK	L1		TCP	TRAFFIC CONTROL PLAN
БТМ	BOTTOM	MAINT	MAINTAIN	TEMP	TEMPORARY
ETW	BETWEEN	MATL(S)	MATERIAL(S)	THK	THICK/THICKNESS
		MAX	MAXIMUM	THRU	THROUGH
C/L	CENTER LINE	MFR(S)	MANUFACTURER('S)	TV	TELEVISION
B	CATCH BASIN	MH(Š)	MANHOLE(S)	ТҮР	TYPICAL
CCTV	CLOSED CIRCUIT TELEVISION	MHÌMÁC	MINOR HOT MIX ASPHALT CONCRETE		
DF	CONTROLLED DENSITY FILL	MIN	MINIMUM	USDOT	UNITED STATES DEPARTMENT OF
I	CAST IRON	MJ	MECHANICAL JOINT		TRANSPORTATION
CIPP	CURED IN PLACE PIPE	MON(S)	MONUMENT(S)		
G	CURB/GUTTER	MUTCD	MANUAL OF UNIFORM TRAFFIC CONTROL DEVICES	VERT	VERTICAL(LY)
ĴL	CLASS			VCP	VITRIFIED CLAY PIPE
CLR	CLEAR	NB	NORTHBOUND		
LSM	CONTROLLED LOW STRENGTH MATERIAL	NO	NUMBER	W	WATER
ND	CONDUIT	NOM	NOMINAL	WB	WESTBOUND
	CLEANOUT	NTS	NOT TO SCALE	WM	WATER METER
COMM	COMMUNICATIONS	00		WZ	WORK ZONE
ONC	CONCRETE	OC	ON CENTER	W/	WITH
ONN		OD ODOT	OUTSIDE DIAMETER	W/IN	WITHIN
ONST	CONSTRUCT/CONSTRUCTION COORDINATE	ODOT OVHD	OREGON DEPARTMENT OF TRANSPORTATION OVERHEAD LINE	W/O	WITHOUT
COORD COP	COPPER		OVERHEAD LINE		
OR	CITY OF ROSEBURG	Р	POWER		
СР	CONCRETE PIPE	PC	POINT OF CURVE		
CPLG	COUPLING	PCC	PORTLAND CEMENT CONCRETE		
R	CRUSHED ROCK	PCMS	PORTABLE CHANGEABLE MESSAGE SIGN		
T	COURT	PCVC	POINT OF CURVATURE ON VERTICAL CURVE		
CHKV	CHECK VALVE	PE	PLAIN END		
CY	CUBIC YARD	PERF	PERFORATED		
		PERM	PERMANENT		
)	DRAIN	PI	POINT OF INTERSECTION		
BH	DIAMETER AT BREAST HEIGHT	PIVC	POINT OF INTERSECTION ON VERTICAL CURVE		
DET(S)	DETAIL(S)	PK	PARKING		
DI	DUCTILE IRON	P/L	PROPERTY LINE		
AIA	DIAMETER	PL	PLACE		
)R	DRIVE	PRESS	PRESSURE		
WG	DRAWING	PROP	PROPOSED		
OWY	DRIVEWAY	PS	PUMP STATION		
		PSI	POUNDS PER SQUARE INCH		
A	EACH	PT	POINT OF TANGENCY		
B	EASTBOUND	PV			
	ELEVATION		POLYVINYL CHLORIDE		
ELEC/E	ELECTRICAL EDGE OF PAVEMENT				
OP O	EDGE OF PAVEMENT	PW	PUBLIC WORKS		
	EQUAL EQUIPMENT	D	RADIUS		
EQUIP ESC	EROSION/SEDIMENTATION CONTROL	R R&R	REMOVE AND REPAIR		
SC SMT	EASEMENT	RCP	REINFORCED CONCRETE PIPE		
XIST	EXISTING	RD	ROAD/ROOF DRAIN		
G	EXISTING EXISTING GRADE	RDCR	REDUCER		
		REHAB	REHABILITATE/REHABILITATION		
AB	FABRICATE	REINF	REINFORCE(D)(ING)(MENT)		
=D	FLOOR DRAIN	REQ'D	REQUIRED		
=H	FIRE HYDRANT	RESTR	RESTRAIN(ED)		
IN GR	FINISHED GRADE	RET	RETAINING		
FL	FLOW LINE	RT	RIGHT		
LG	FLANGE(D)	R/W	RIGHT OF WAY		
FM	FORCE MAIN				
0	FIBER OPTIC	SB	SOUTHBOUND		
T	FEET/FOOT	SCHED	SCHEDULE		
TG	FITTING	SD	STORM DRAIN		
		SDMH	STORM DRAIN MANHOLE		
3	GAS	SHT(S)	SHEET(S)		
GALV	GALVANIZED	SLP	SLOPE		
SR	GRADE	SPECS	SPECIFICATIONS		
·	GRAVEL	SPL	SPOOL		
GRVL					
GRVL GV	GATE VALVE	SPR	SANITARY POINT REPAIR		
	GATE VALVE	SPR SQ SQ FT	SQUARE SQUARE FOOT		

900 SE DOUGLAS AVE. ROSEBURG, OR 97470

CITY PROJECT #: 22PW01 PH 2 CITY PROJECT MANAGER **RICK CASTLE**

LEGEND & ABBREVIATIONS

STEPHENS STREET PAVEMENT IMPROVEMENTS MAY 2022

SHEET NO.

G-02

2 OF 14

1. ALL WORK AND MATERIALS SHALL CONFORM TO THE 2021 EDITION OF THE OREGON CHAPTER APWA STANDARD SPECIFICATIONS FOR PUBLIC WORKS CONSTRUCTION.

2. IT SHALL BE THE RESPONSIBILITY OF THE CONTRACTOR TO OBTAIN AND PAY FOR ALL APPLICABLE PERMITS, LICENSES AND CERTIFICATES RELATIVE TO THE TRADES TO COMPLETE THE PROJECT AND FOR THE USE OF SUCH WORK WHEN COMPLETED. COMPLIANCE SHALL BE AT ALL LEVELS, FEDERAL, STATE, COUNTY, AND LOCAL, RELATING TO THE PERFORMANCE OF THE WORK.

3. IT SHALL BE THE RESPONSIBILITY OF THE CONTRACTOR TO VERIFY ALL UTILITY LOCATIONS PRIOR TO CONSTRUCTION AND ARRANGE FOR THE RELOCATION OF ANY UTILITIES IN CONFLICT WITH THE PROPOSED CONSTRUCTION. THE LOCATIONS, DEPTH AND DESCRIPTION OF EXISTING UTILITIES SHOWN WERE COMPILED FROM AVAILABLE RECORDS. THE ENGINEER OR UTILITY COMPANIES DO NOT GUARANTEE THE ACCURACY OR THE COMPLETENESS OF SUCH RECORDS. ADDITIONAL UTILITIES, OTHER THAN THOSE SHOWN, MAY EXIST WITHIN THE WORK AREA.

4. OREGON LAW REQUIRES THAT THE RULES ADOPTED BY OREGON UTILITY NOTIFICATION CENTER BE FOLLOWED. THOSE RULES ARE SET FORTH IN OAR 952-001-0010 THROUGH OAR 952-001-0090. YOU MAY OBTAIN COPIES OF THE RULES BY CALLING THE CENTER OR ACCESSING VIA INTERNET AT WWW.CALLBEFOREYOUDIG.ORG. CALL BEFORE YOU DIG - 811.

5. THE CONTRACTOR SHALL MAKE PROVISIONS TO KEEP ALL EXISTING UTILITIES IN SERVICE AND PROTECT THEM DURING CONSTRUCTION. CONTRACTOR SHALL IMMEDIATELY REPAIR OR REPLACE ANY DAMAGED UTILITIES USING MATERIALS AND METHODS APPROVED BY THE UTILITY OWNER. NO SERVICE INTERRUPTIONS SHALL BE PERMITTED WITHOUT PRIOR WRITTEN AGREEMENT WITH THE UTILITY PROVIDER.

6. CONTRACTOR SHALL NOTIFY THE ENGINEER AND THE CITY OF ROSEBURG 48 HOURS IN ADVANCE OF STARTING CONSTRUCTION AND 24 HOURS BEFORE RESUMING WORK AFTER SHUTDOWNS, EXCEPT FOR NORMAL RESUMPTION OF WORK FOLLOWING SATURDAYS, SUNDAYS, OR HOLIDAYS.

7. CONTRACTOR SHALL REMOVE AND DISPOSE OF CONCRETE, ASPHALT CEMENT, TOPSOIL, AND OTHER MATERIAL IN THE WORK LIMITS AND WHERE INDICATED ON THE PLANS. MATERIAL SHALL BE DISPOSED OF IN SUCH A MANNER AS TO MEET ALL APPLICABLE REGULATIONS. CONTRACTOR SHALL ENSURE RECIPIENTS OF FILL MATERIALS REMOVED OFFSITE ARE PERMITTED TO RECEIVE SAID MATERIALS REGARDLESS OF THE RECEIVING JURISDICTION.

8. LIMIT HOURS OF PAVING CONSTRUCTION TO BETWEEN 7:00 PM TO 7:00 AM, LIMIT HOURS OF ALL OTHER CONSTRUCTION TO BETWEEN 7:00AM TO 6:00PM, MONDAY THROUGH FRIDAY. CONSTRUCTION IN ALL PROJECT AREAS IS PROHIBITED ON SATURDAYS, SUNDAYS AND HOLIDAYS, AS STATED IN SECTION 220.40(E) OF THE SPECIAL PROVISIONS. SEE SECTION 00220 OF THE SPECIAL PROVISIONS FOR ALLOWABLE LANE CLOSURES.

9. THE CONTRACTOR SHALL KEEP AN APPROVED SET OF PLANS ON THE PROJECT SITE AT ALL TIMES.

10. IT IS THE CONTRACTOR'S RESPONSIBILITY TO VISIT THE SITE AND VERIFY ALL EXISTING CONDITIONS BEFORE THE START OF WORK. THE CONTRACTOR SHALL TAKE ALL NECESSARY FIELD MEASUREMENTS AND OTHERWISE VERIFY ALL DIMENSIONS AND EXISTING CONSTRUCTION CONDITIONS INDICATED AND/OR SHOWN ON THE PLANS. SHOULD ANY ERROR OR INCONSISTENCY EXIST, THE CONTRACTOR SHALL NOT PROCEED WITH THE WORK AFFECTED UNTIL REPORTED TO THE ENGINEER FOR CLARIFICATION OR CORRECTION.

11. ANY INSPECTION BY THE CITY, COUNTY, STATE, FEDERAL AGENCY OR ENGINEER SHALL NOT, IN ANY WAY, RELIEVE THE CONTRACTOR FROM ANY OBLIGATION TO PERFORM THE WORK IN COMPLIANCE WITH THE APPLICABLE CODES, REGULATIONS, CITY STANDARDS AND PROJECT CONTRACT DOCUMENTS.

12. CONTRACTOR SHALL COORDINATE ALL IMPROVEMENT LIMITS WITH THE ENGINEER ONSITE PRIOR TO BEGINNING WORK. NO PAYMENT WILL BE MADE FOR EXTRA WORK THAT IS CONSTRUCTED BEYOND THE APPROVED CONSTRUCTION LIMITS.

13. AT THE END OF EACH WORK DAY, THE CONTRACTOR SHALL CLEAN UP THE PROJECT AREA AND LEAVE IT IN A NEAT AND SECURED MANNER. UPON COMPLETION OF THE PROJECT, THE CONTRACTOR SHALL LEAVE THE PROJECT AREA FREE FROM ALL DEBRIS AND UNUSED MATERIALS.

14. PROPERTY LINES SHOWN ON PLAN SHEETS ARE APPROXIMATE AND FOR GENERAL DELINEATION PURPOSES ONLY AND ARE NOT MEANT TO REPRESENT THE ACTUAL PROPERTY BOUNDARIES.

15. THE CONTRACTOR SHALL BE SOLELY RESPONSIBLE FOR COMPLYING WITH ALL CONSTRUCTION SAFETY, HEALTH AND OTHER RULES AND REGULATIONS FROM OSHA, DEQ, STATE, AND LOCAL REGULATING AGENCIES FOR SAFETY AND INSTALLATION OF THE WORK INCLUDING, BUT NOT LIMITED TO, SHORING, BRACING, ERECTION/INSTALLATION, FALL PROTECTION, GUARDRAILS, ETC.

16. REPLACE CURBS, SIDEWALKS, AND/OR DRIVEWAY APRONS THAT ARE DAMAGED AS A RESULT OF CONSTRUCTION OPERATIONS. REPLACE FULL SECTIONS TO THE NEAREST EXISTING CONSTRUCTION JOINT. REPLACEMENT WILL BE CONSIDERED INCIDENTAL TO THE WORK.

17. ALL CONSTRUCTION SURVEY AND STAKING REQUIRED FOR THE PROJECT SHALL BE PROVIDED BY THE CONTRACTOR. THE CONTRACTOR SHALL DEVELOP AND MAKE ALL DETAIL SURVEYS NECESSARY FOR LAYOUT AND CONSTRUCTION INCLUDING EXACT COMPONENT LOCATION (SUCH AS EXISTING STRIPING, SYMBOLS, DETECTOR LOOPS, ETC), WORKING POINTS, LINES, AND ELEVATIONS. PRIOR TO CONSTRUCTION, THE FIELD LAYOUT SHALL BE REVIEWED BY THE ENGINEER.

NO.	DATE	DATE BY REVISION		S	SCALE	DESIGNED:	
				PLAN	AS SHOWN	A. FISCHER	000
						DRAWN:	LE
					HORIZ.	E. WILSON	
				PROFILE	VERT.	CHECKED:	
						R. VOORHIES	RAN
				ONE	INCH (REF)	CWE PROJECT NO.	
						40193.019.01	E

18. THE CONTRACTOR SHALL HAVE THE RESPONSIBILITY TO CAREFULLY PRESERVE BENCHMARKS, REFERENCE POINTS AND STAKES, AND IN THE CASE OF DESTRUCTION THEREOF BY THE CONTRACTOR RESULTING FROM ITS NEGLIGENCE, THE CONTRACTOR SHALL BE CHARGED WITH THE EXPENSE AND DAMAGE RESULTING THEREFORE AND SHALL BE RESPONSIBLE FOR ANY MISTAKES THAT MAY BE CAUSED BY THE UNNECESSARY LOSS OR DISTURBANCE OF SUCH MARKS, REFERENCE POINTS AND STAKES.

19. CONTRACTOR IS RESPONSIBLE FOR SURVEYING AND REPLACING ALL MONUMENTS DISTURBED BY PAVING OR CONCRETE WORK PURSUANT TO ORS 209.150, AND FOR PREPARING AND FILING A RECORD OF SURVEY TO THE COUNTY SURVEYOR'S OFFICE PURSUANT TO ORS 209.250.

20. COORDINATE WITH OTHER CONTRACTORS WITHIN THE PROJECT LIMITS COMPLETING WORK. IF APPLICABLE, SEE THE GENERAL CONDITIONS OF THE SPECIFICATIONS FOR CONTACT INFORMATION.

21. PROTECT FRESHLY POURED CONCRETE CURBS AND SIDEWALK FROM VANDALISM OR OTHER DAMAGE FOR A MINIMUM OF TWENTY-FOUR (24) HOURS OR UNTIL CURED ENOUGH TO SUPPORT TYPICAL USE, WHICHEVER IS LONGER. ANY CURB OR SIDEWALK DAMAGED BY VANDALISM OR OTHER CAUSES SHALL BE REPLACED AT NO COST TO THE CITY.

22. CONTRACTOR SHALL RESTORE ALL DISTURBED LANDSCAPING AND IRRIGATION. PLACE TOPSOIL, AGGREGATE, AND/OR BARK MULCH WHERE SHOWN.

23. FURNISH AND PLACE DOWELS TO JOIN NEW CONCRETE WALKS, CURBS AND DRIVEWAYS TO EXISTING CONCRETE AS DIRECTED.

24. LIMIT THE TIME ANY ADA RAMP IS CLOSED TO 10 CALENDAR DAYS.

EROSION CONTROL NOTES

1. ALL EROSION AND SEDIMENT CONTROL MEASURES ARE TO BE PLACED PRIOR TO ANY DISTURBANCE CAUSED BY GRADING AND SHALL CONFORM TO THE REQUIREMENTS OF STATE AND FEDERAL REGULATIONS AND TO THE SPECIFIC REQUIREMENTS CONTAINED IN THE SPECIFICATIONS.

2. EXISTING INLETS AND CATCH BASINS THAT MAY RECEIVE RUNOFF FROM THE PROJECT AREA ARE TO BE PROTECTED PRIOR TO CONSTRUCTION. ALL INLETS AND CATCH BASINS ARE TO BE PROTECTED IN ACCORDANCE WITH ODOT/APWA STANDARDS FOR EROSION AND SEDIMENT CONTROL

3. IN THE EVENT OF ANY EROSION CONTROL MEASURE FAILURE, IMMEDIATE ACTION SHALL BE TAKEN TO REPAIR, REPLACE, OR CONSTRUCT ADDITIONAL MEASURES AS REQUIRED TO ENSURE ADEQUATE EROSION CONTROL PROTECTION.

4. ALL EROSION CONTROL MEASURES SHALL BE INSPECTED REGULARLY, PARTICULARLY DURING AND AFTER STORM EVENTS, TO ENSURE ADEQUATE PERFORMANCE. MAINTENANCE AND INSPECTION LOGS SHALL REMAIN ON SITE AND SHALL BE AVAILABLE TO THE CITY OF ROSEBURG UPON REQUEST.

5. ALL PESTICIDES, PETROLEUM PRODUCTS, CHEMICALS OR OTHER POTENTIAL POLLUTANTS SHALL BE ADMINISTERED RESPONSIBLY WITH DISPOSAL AND SPILLS HANDLED IN ACCORDANCE WITH ALL LOCAL STATE AND FEDERAL REOUIREMENTS.

PAVING NOTES

1. TRIM VEGETATION AS NEEDED PRIOR TO PAVING TO ENSURE ALL VEGETATION IS CLEAR OF PAVING OPERATIONS.

2. ALL EDGES REMAINING AFTER COLD PLANE PAVEMENT REMOVAL, IF APPLICABLE, SHALL BE VERTICAL TO ACCEPT THE SUCCEEDING FULL DEPTH ASPHALT LIFT.

3. ALL JOINTS BETWEEN NEW ASPHALTIC CONCRETE AND EXISTING OR NEW ASPHALTIC CONCRETE AND CONCRETE SHALL BE TACKED AND SAND SEALED.

4. PROVIDE MINOR ADJUSTMENTS IN GRADE OF NEW A.C. AS REQUIRED TO FACILITATE DRAINAGE INTO STORM DRAINAGE FACILITIES. NO PONDING SHALL OCCUR BETWEEN CATCH BASINS FOLLOWING CONSTRUCTION.

5. THE MAXIMUM EXPOSURE AT DRIVEWAYS SHALL BE 3/4-INCH.

6. WHERE PAVEMENT IS TO BE REPLACED TO MATCH EXISTING GRADE ADJACENT TO EXISTING CURB, CONTRACTOR SHALL MARK EXISTING CURB FLOW LINE WITH PAINT PRIOR TO A.C. SURFACING REMOVAL.

7. COORDINATE WITH CITY STAFF FOR IN-GROUND VALVE, MANHOLE OR VAULT ADJUSTMENT OF FRANCHISE UTILITY ASSETS.

STRIPING AND SIGNING NOTES

1. ALL SIGNING AND PAVEMENT MARKING MATERIAL AND WORKMANSHIP SHALL CONFORM TO THE REQUIREMENTS AND SPECIFICATIONS OF THE MANUAL ON UNIFORM TRAFFIC CONTROL DEVICES (MUTCD), AND 2021 APWA STANDARD SPECIFICATIONS.

2. ALL LONGITUDINAL STRIPING SHALL BE PAINT. TRANSVERSE PAVEMENT MARKINGS, INCLUDING CROSSWALKS, STOP BARS, BIKE SYMBOLS, ARROWS, AND STORM INLET MARKINGS, SHALL BE PREFORMED THERMOPLASTIC AS SHOWN AND SPECIFIED. CONTRACTOR IS RESPONSIBLE FOR LAYOUT AND STAKING OF ALL TRANSVERSE PAVEMENT MARKINGS.

3. TEMPORARY FLEXIBLE PAVEMENT MARKERS ARE ALLOWED PRIOR TO STRIPING FOR A MAXIMUM PERIOD OF 14 CALENDAR DAYS.

4. CONTRACTOR SHALL OBTAIN CITY APPROVAL OF STRIPING LAYOUT 24 HOURS BEFORE STRIPING.

5. LANE DIMENSIONS SHALL BE MEASURED FROM CENTER OF STRIPE OR FROM EDGE OF PAVEMENT OR CURB TO CENTER OF STRIPE.

TRAFFIC CONTROL NOTES

1. TRAFFIC CONTROL/DETOUR PLANS SHALL BE PREPARED BY THE CONTRACTOR. THE DRAFT CONCEPT TRAFFIC CONTROL PLAN MUST BE APPROVED BY THE CITY PRIOR TO THE PRE-CONSTRUCTION CONFERENCE. THIS PLAN DOES NOT RELIEVE THE CONTRACTOR FROM SUBMITTING DETAILED TRAFFIC CONTROL PLANS AS REQUIRED DURING CONSTRUCTION.

2. THE CONTRACTOR SHALL PROVIDE TEMPORARY PROTECTION AND DIRECTION OF TRAFFIC IN ACCORDANCE WITH THE MANUAL OF UNIFORM TRAFFIC CONTROL DEVICES, ODOT STANDARD DRAWINGS, ODOT STANDARD SPECIFICATIONS, AND CONTRACT SPECIAL PROVISIONS.

3. USE TEMPORARY PAVEMENT MARKERS, BARRIERS, BARRICADES, AND SIGNS AS REQUIRED TO SAFELY DETOUR PEDESTRIAN AND VEHICULAR TRAFFIC AROUND CONSTRUCTION. LABEL TYPE AND LOCATION FOR ALL ITEMS ON TRAFFIC CONTROL PLANS.

4. APPROPRIATE METHODS OF PEDESTRIAN AND VEHICULAR TRAFFIC CONTROL, INCLUDING FLAGGERS, SHALL BE EMPLOYED BY THE CONTRACTOR TO THE EXTENT DEEMED NECESSARY BY THE TRAFFIC CONTROL SUPERVISOR AND AS APPROVED BY THE CITY AND THE ENGINEER TO PROTECT WORKERS OR THIRD PARTIES AND SAFELY ACCOMMODATE TRAFFIC THROUGH THE WORK ZONE.

5. THE CONTRACTOR SHALL COORDINATE ACCESS TO DRIVEWAYS WITH PROPERTY OWNERS. ACCESS TO ROADWAY APPROACHES WITHIN THE PROJECT LIMITS SHALL BE MAINTAINED AT ALL TIMES. TRAFFIC PLATES SHALL BE USED, AND SECURED IN A MANNER ACCEPTABLE TO THE CITY, ACROSS ALL TRENCHES BLOCKING DRIVEWAYS TO PROVIDE ACCESS AT ALL TIMES. AT NO TIME SHALL CONTRACTORS DETAIN OR DELAY EMERGENCY VEHICLES.

6. THE CONTRACTOR SHALL COORDINATE ACCESS FOR SERVICES INCLUDING, BUT NOT LIMITED TO, MAIL DELIVERY, TRASH PICKUP, SCHOOL TRANSPORTATION, AND ANY OTHER SPECIAL TRANSPORTATION SERVICES THAT EXIST WITHIN THE PROJECT AREA.

7. EXISTING SIGNS THAT CONFLICT WITH CONSTRUCTION SIGNING SHALL BE COVERED OR REMOVED DURING CONSTRUCTION AND REPLACED AFTER CONSTRUCTION.

8. PROVIDE ACP WEDGES FOR LONGITUDINAL AND TRANSVERSE JOINTS ACCORDING TO 00620.40(d), 00744.44 AND 00744.45.

9. THE CONTRACTOR SHALL PROVIDE SAFE, STABLE, AND ACCESSIBLE ACCESS TO ALL DRIVEWAY AND PEDESTRIAN PATHS CONNECTING TO FRONT DOORS AT ALL TIMES. TEMPORARY INTERRUPTIONS IN ACCESS SHALL BE COORDINATED BY THE CONTRACTOR WITH THE PROPERTY OWNER OR OCCUPANT AS REOUIRED.

10. CONTRACTOR SHALL FURNISH PORTABLE CHANGEABLE MESSAGE SIGN AT WORK ZONES ON ARTERIAL ROADS IN ACCORDANCE WITH THE SPECIFICATIONS.

11. COLD PLANE PAVEMENT REMOVAL SHALL BE COMPLETED ON THE SAME SHIFT AS THE PERMANENT ASPHALT PAVEMENT WEARING COURSE.







900 SE DOUGLAS AVE. ROSEBURG, OR 97470

CITY PROJECT #: 22PW01 PH 2 CITY PROJECT MANAGER **RICK CASTLE**



Know what's **below**. Call before you dig


GENERAL NOTES


STEPHENS STREET PAVEMENT IMPROVEMENTS MAY 2022

SHEET NO.

G-03

3 OF 14

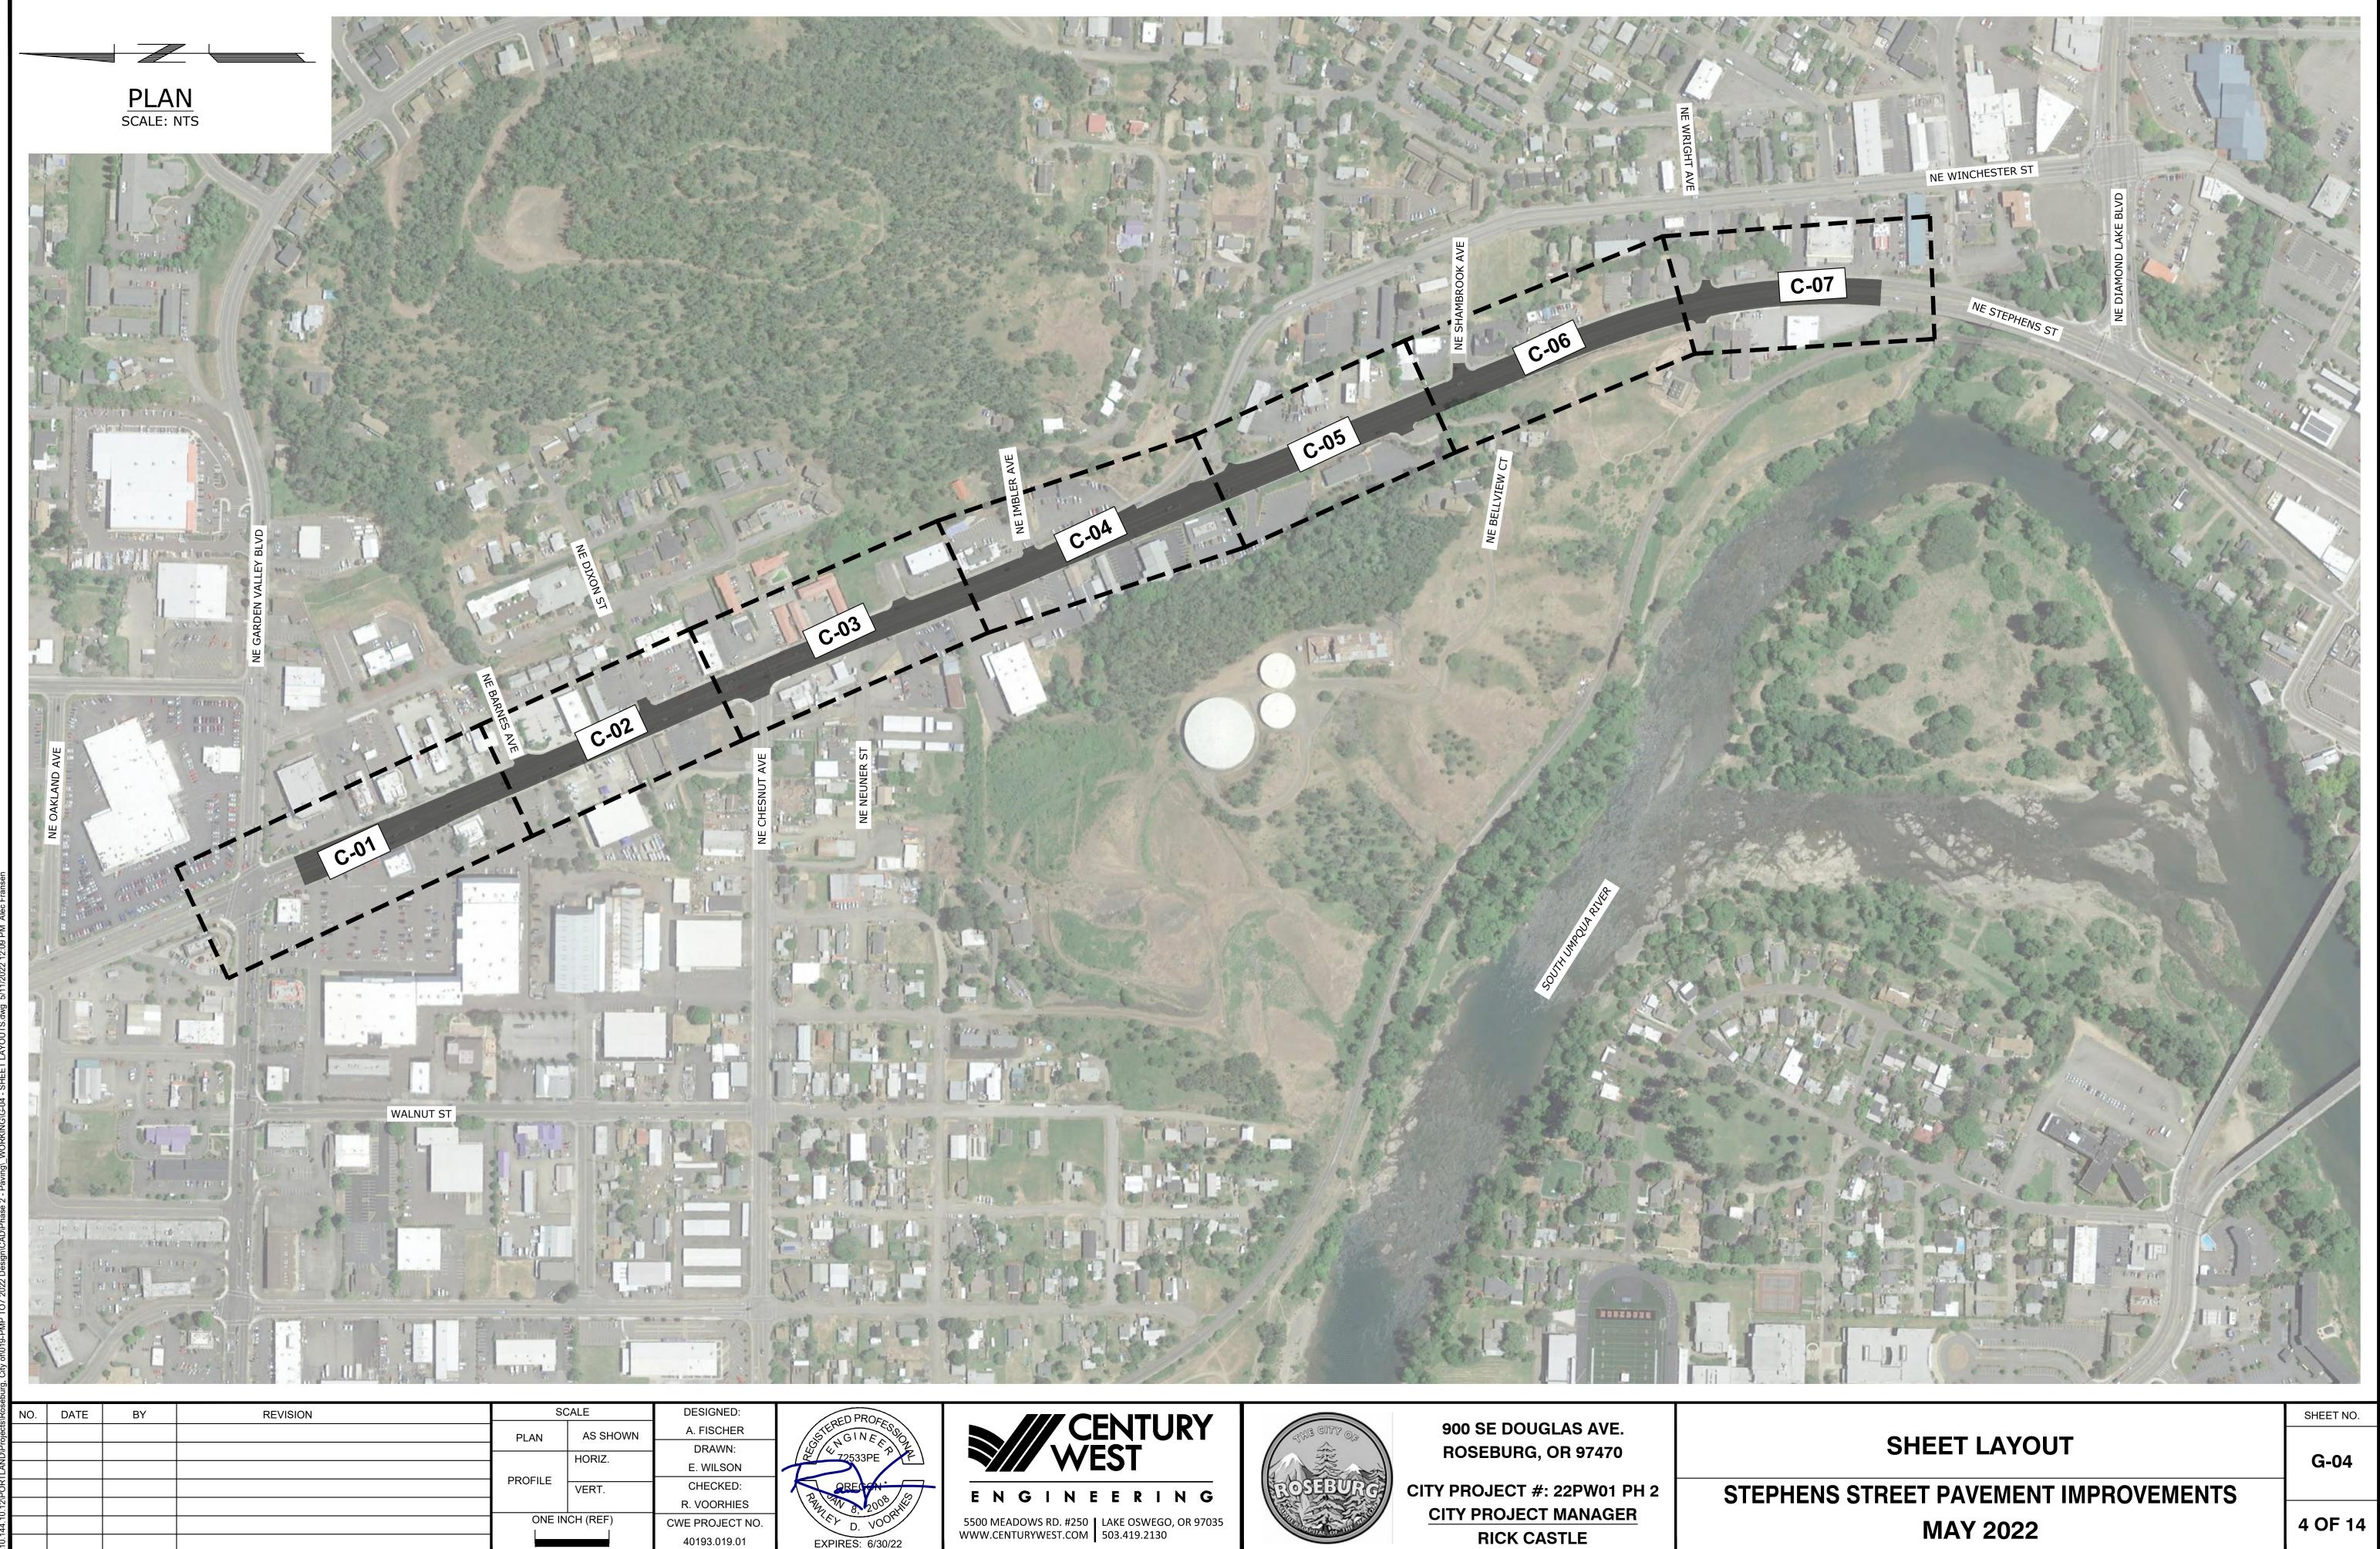

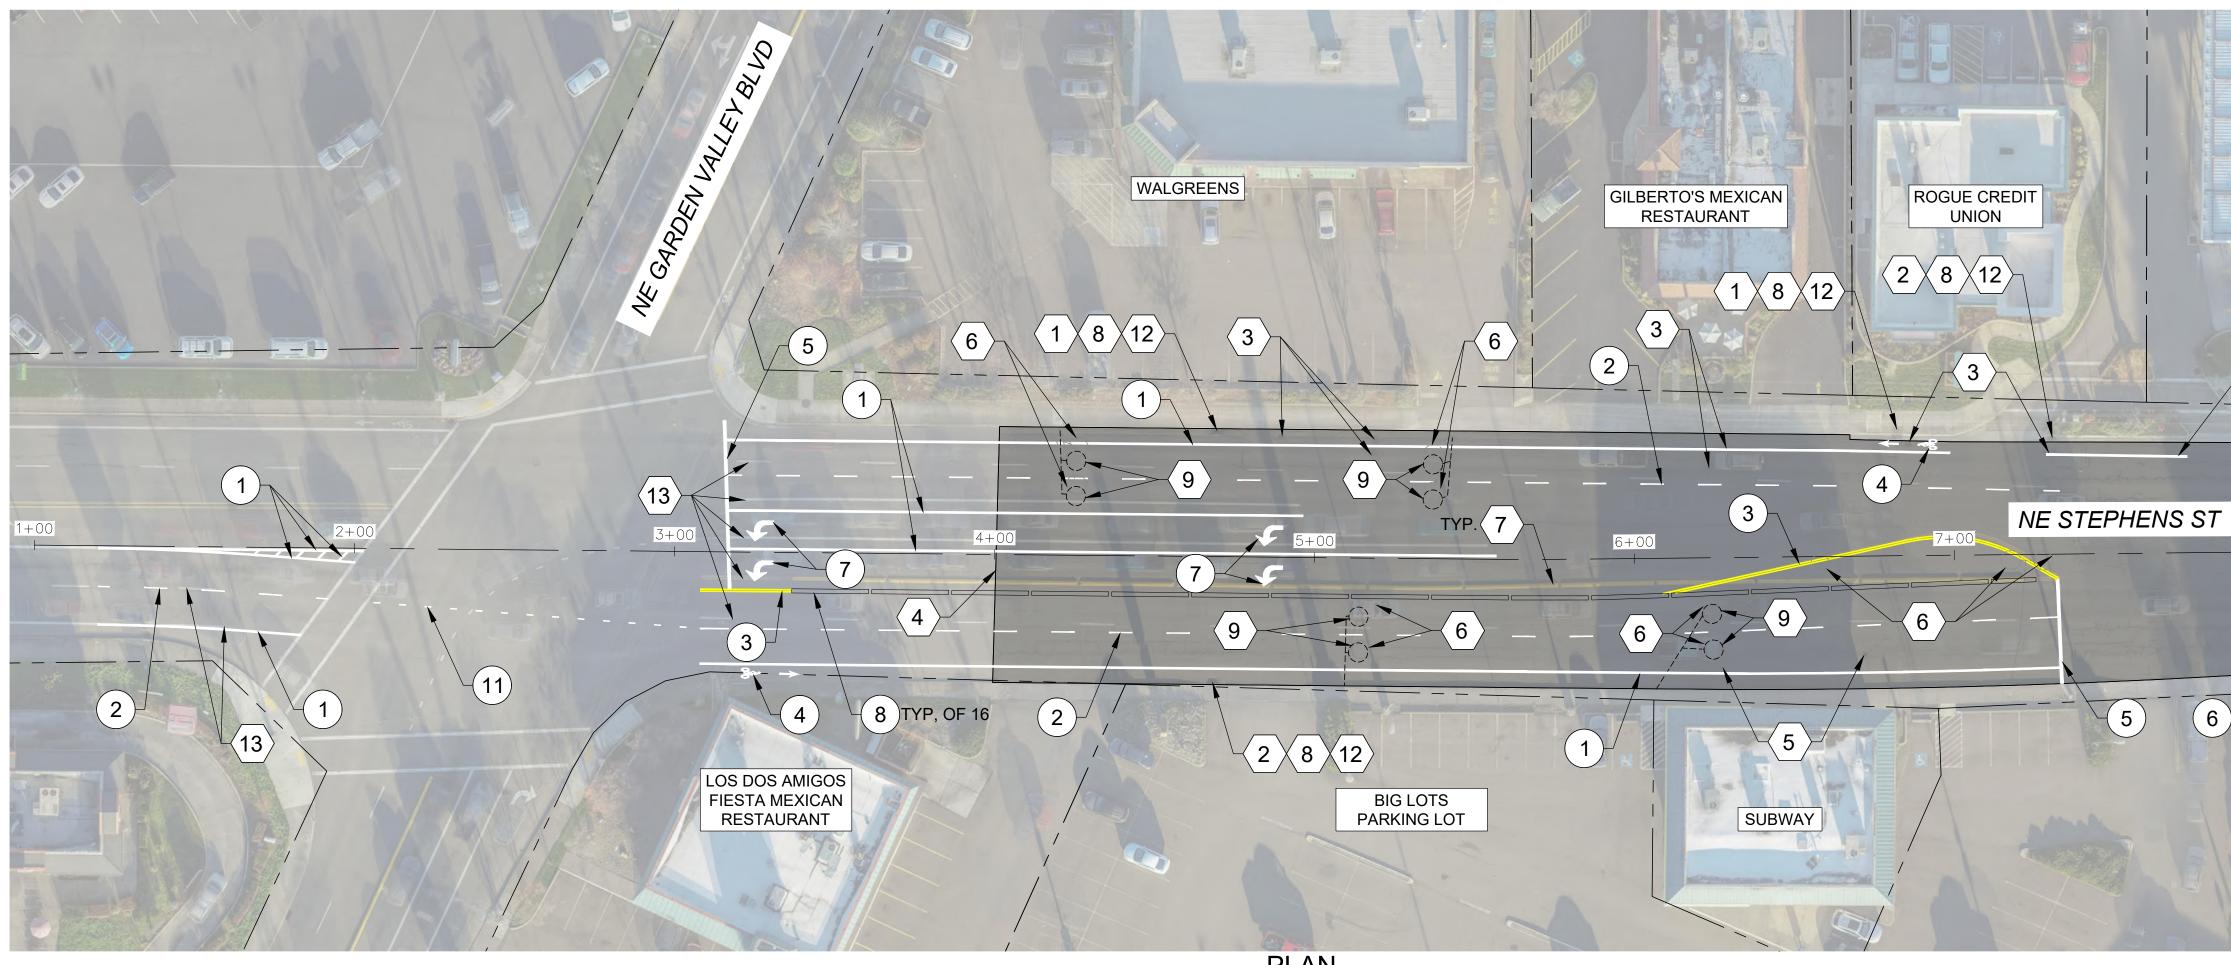

1. PAVE TO LIMITS SHOWN. SEE TYPICAL SECTION ON SHEET D-01.

2. APPLY LANE CLOSURES DURING PAVING OPERATIONS PER ODOT STANDARD DRAWING TM850, OR APPROVED TRAFFIC CONTROL PLAN.

LEGEND:

AC PAVING AND COLD PLANE PAVEMENT REMOVAL LIMITS. SEE SECTION & DETAILS ON SHEETS D-01 & D-02.

CONSTRUCTION KEYED NOTES:

 $\langle 13 \rangle$

	INSTALL INLET PROTECTION TY
2	INSTALL INLET PROTECTION TY
3	LOWER EXISTING MANHOLE BE COLD PLANE PAVEMENT REMO TO FINISH GRADE FOLLOWING
4	MATCH EXISTING GRADE. SEE
5	ADJUST EXISTING WATER VAL
6	REMOVE EXISTING INDUCTION
$\langle 7 \rangle$	REMOVE EXISTING TRAFFIC SE
8	PRESERVE & PROTECT IN PLAC
9	INSTALL NEW 6' ROUND INDUC STANDARD DRAWINGS TM475 LOCATION SHOWN OR AS DIRE PERMANENT PAVEMENT MARK
(12)	INSTALL STORM DRAIN MARKIN

INSTALL STORM DRAIN MARKING STENCIL PER DETAIL 4 ON SHEET D-02.

REMOVE EXISTING STRIPING WITHIN LIMITS OF NEW STRIPING SHOWN. VERIFY EXTENTS WITH ENGINEER PRIOR TO REMOVAL.


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	A. FISCHER	AS SHOWN	PLAN				
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	R. VOORHIES						
О.	CWE PROJECT NO.	NCH (REF)					
	40193.019.01						

PLAN SCALE: 1"=30'

TYPE 10 PER ODOT STANDARD DRAWING RD1010.

TYPE 3 PER ODOT STANDARD DRAWING RD1010.

BELOW THE PROPOSED PAVING DEPTH PRIOR TO 10VAL. ADJUST EXISTING STORM SEWER MANHOLE G PAVING OPERATIONS. SEE DETAIL 1 ON SHEET D-02.

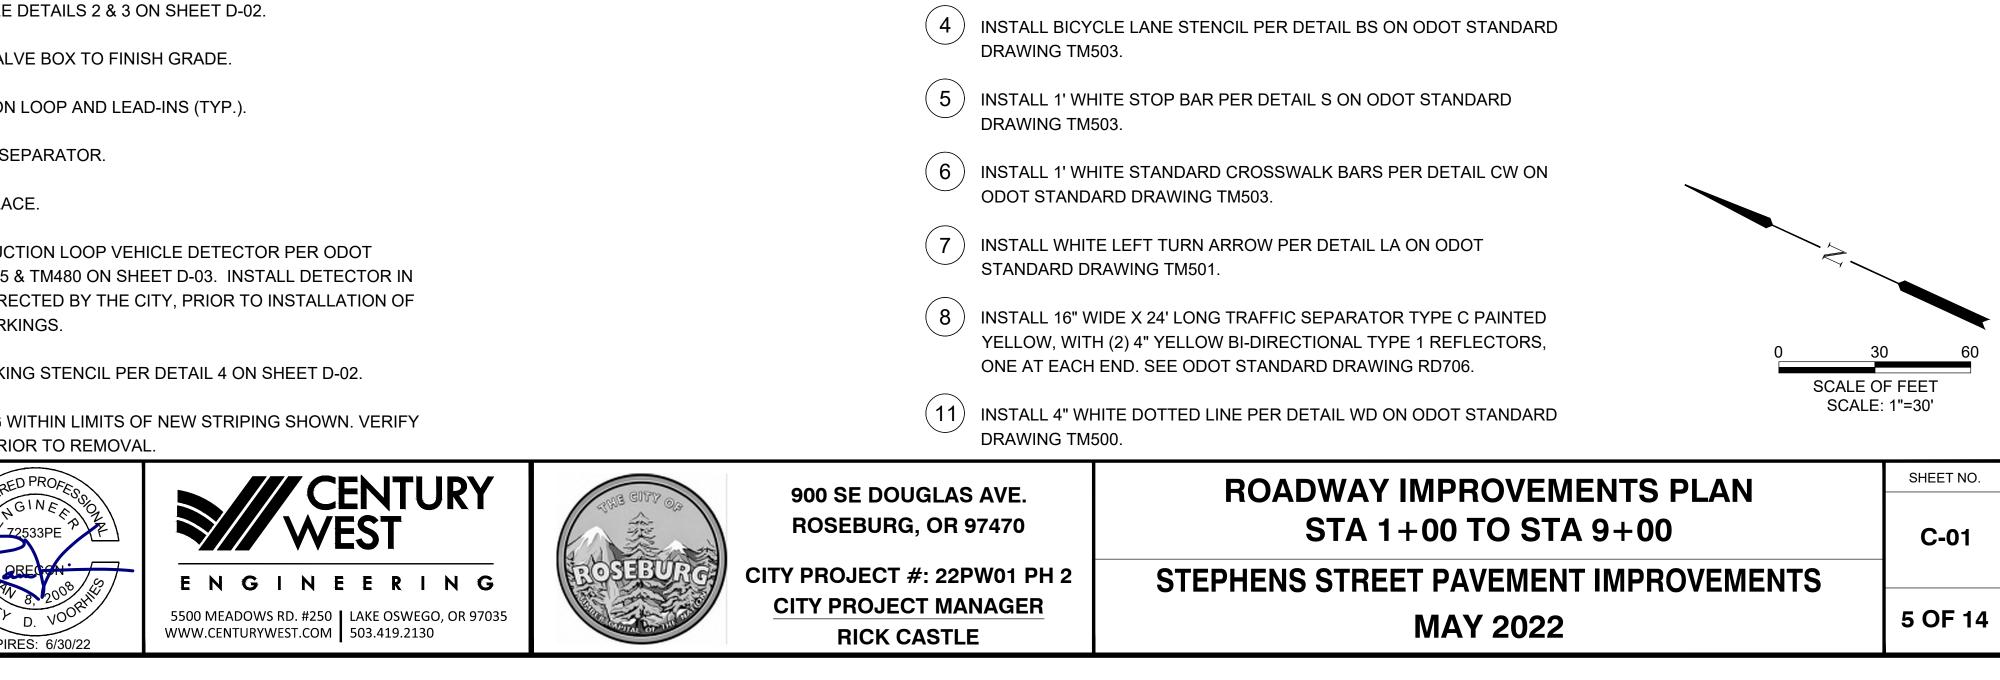

PAVEMENT MARKING KEYED NOTES:

DRAWING TM500.

1)

(2) INSTALL 4" WHITE BROKEN LINE WITH REFLECTORS PER DETAIL WB/R-40 ON ODOT STANDARD DRAWING TM502.


(3) INSTALL 4" NARROW DOUBLE YELLOW LINES WITH REFLECTORS PER

DETAIL ND/R-20 ON ODOT STANDARD DRAWING TM502.

INSTALL 8" WHITE LINE PER DETAIL W-2 ON ODOT STANDARD

2 4 6) 2 CHINA BUFFET

SONIC DRIVE-IN 00 02 တ **ა** ⊢ SHE SEE A N

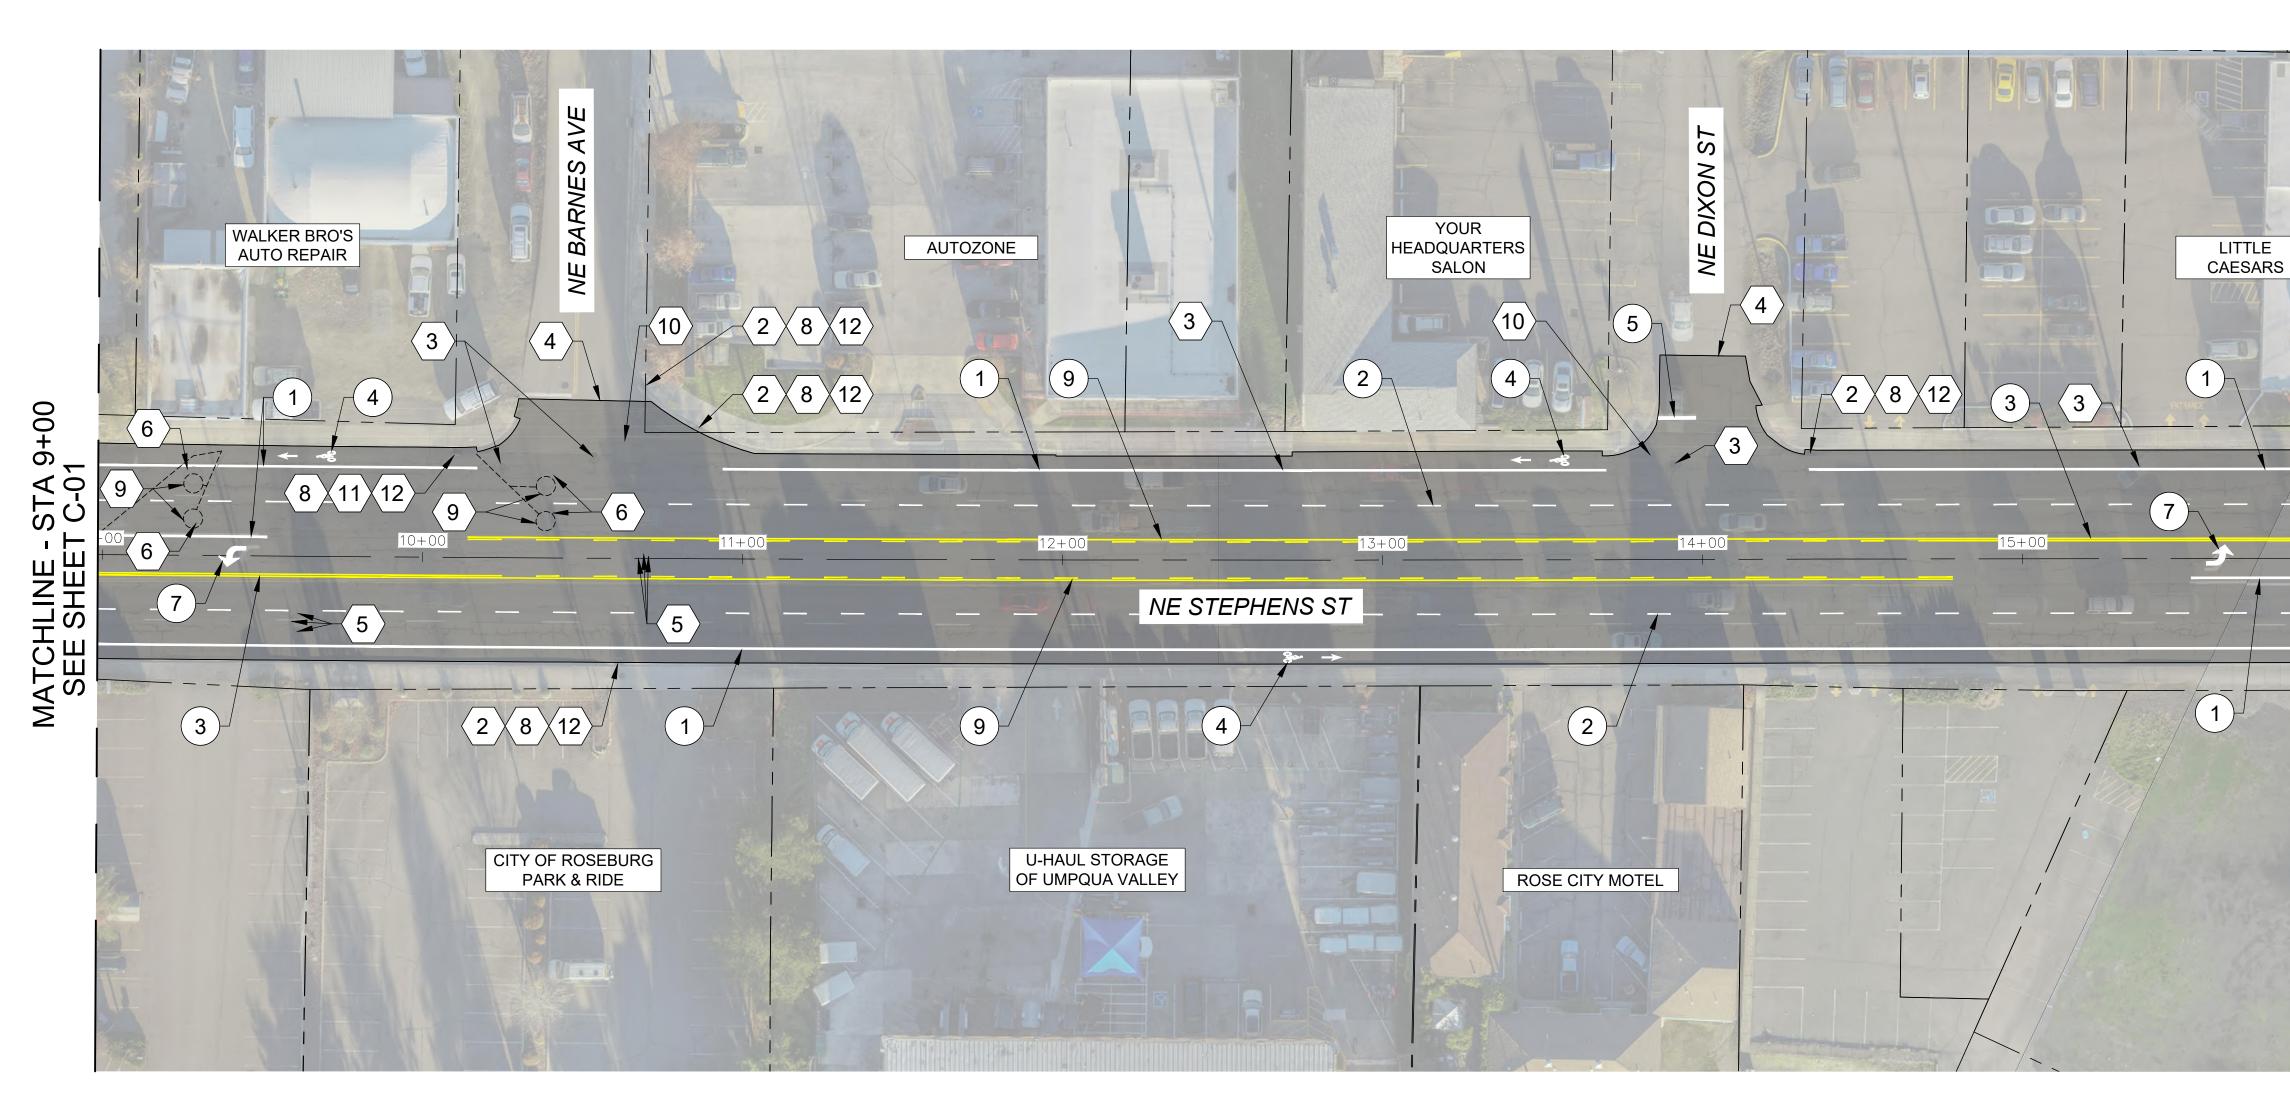

1. PAVE TO LIMITS SHOWN. SEE TYPICAL SECTION ON SHEET D-01.

2. APPLY LANE CLOSURES DURING PAVING OPERATIONS PER ODOT STANDARD DRAWING TM850, OR APPROVED TRAFFIC CONTROL PLAN.

LEGEND:




AC PAVING AND COLD PLANE PAVEMENT REMOVAL LIMITS. SEE SECTION & DETAILS ON SHEETS D-01 & D-02.

NO.	DATE	BY REVISION		S	SCALE	DESIGNED:	
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					HORIZ.	E. WILSON	
				PROFILE	VERT.	CHECKED:	
						R. VOORHIES	REAL
				ONE I	NCH (REF)	CWE PROJECT NO.	
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\Roseburg, City of\019-PMP TO7 2022 Design\CAD\Phase 2 - Paving\ WORKING\C-01 - C-04 - ROADWAY PLANS.dwg 5/11/2022 12:11 PM Ale

PLAN SCALE: 1"=30'

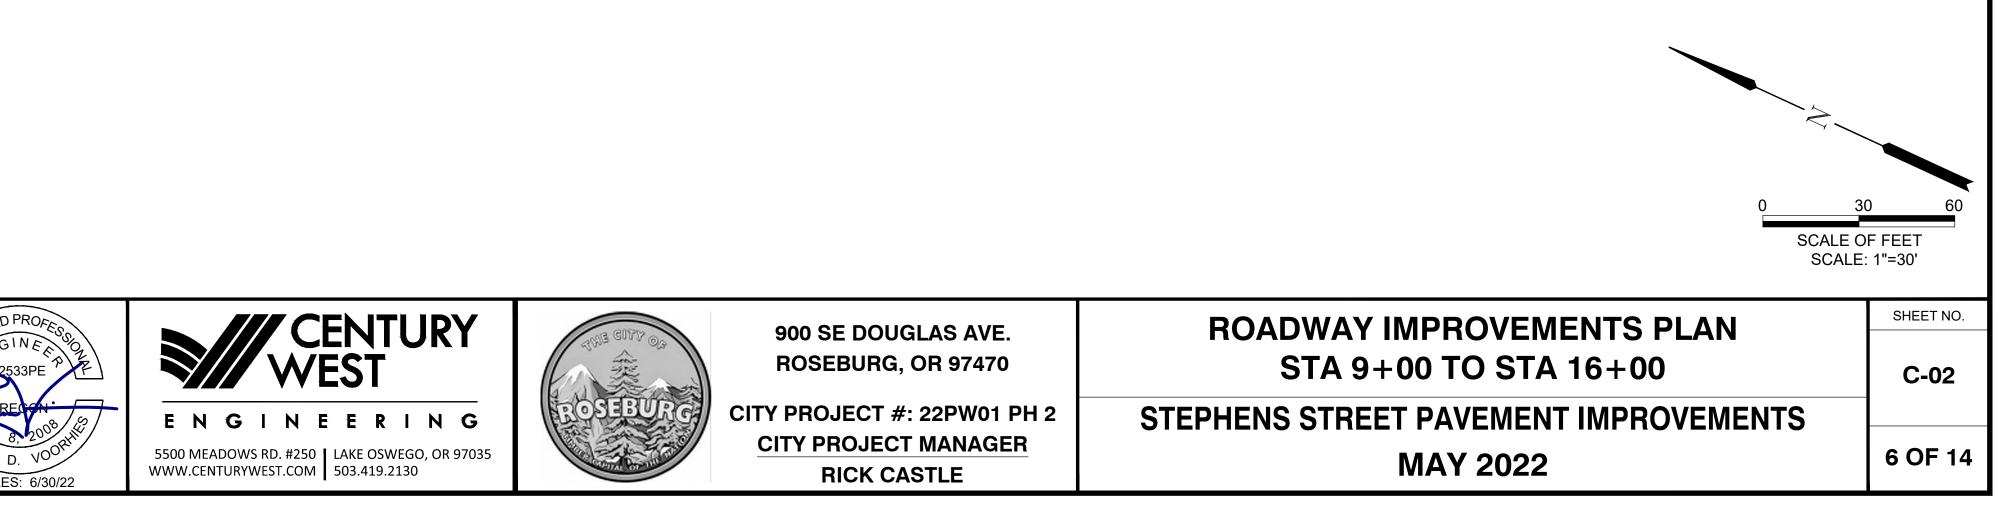

CONSTRUCTION KEYED NOTES:



(2)

〔5〕

(6)


(8)

INSTALL INLET PROTECTION TYPE 3 PER ODOT STANDARD DRAWING RD1010.

- 3 LOWER EXISTING MANHOLE BELOW THE PROPOSED PAVING DEPTH PRIOR TO COLD PLANE PAVEMENT REMOVAL. ADJUST EXISTING STORM SEWER MANHOLE TO FINISH GRADE FOLLOWING PAVING OPERATIONS. SEE DETAIL 1 ON SHEET D-02.
- 4 MATCH EXISTING GRADE. SEE DETAILS 2 & 3 ON SHEET D-02.
 - ADJUST EXISTING WATER VALVE BOX TO FINISH GRADE.
 - REMOVE EXISTING INDUCTION LOOP AND LEAD-INS (TYP.).
 - PRESERVE & PROTECT IN PLACE.

9 INSTALL NEW 6' ROUND INDUCTION LOOP VEHICLE DETECTOR PER ODOT STANDARD DRAWINGS TM475 & TM480 ON SHEET D-03. INSTALL DETECTOR IN LOCATION SHOWN OR AS DIRECTED BY THE CITY, PRIOR TO INSTALLATION OF PERMANENT PAVEMENT MARKINGS.

 $\langle 10 \rangle$ ADJUST EXISTING GAS VALVE BOX TO FINISH GRADE.

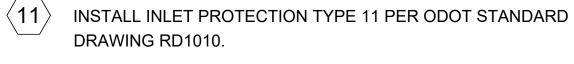


(12) INSTALL STORM DRAIN MARKING STENCIL PER DETAIL 4 ON SHEET D-02.

PAVEMENT MARKING KEYED NOTES:

- 1 INSTALL 8" WHITE LINE PER DETAIL W-2 ON ODOT STANDARD DRAWING TM500.
- (2) INSTALL 4" WHITE BROKEN LINE WITH REFLECTORS PER DETAIL WB/R-40 ON ODOT STANDARD DRAWING TM502.
- (3) INSTALL 4" NARROW DOUBLE YELLOW LINES WITH REFLECTORS PER DETAIL ND/R-40 ON ODOT STANDARD DRAWING TM502.
- (4) INSTALL BICYCLE LANE STENCIL PER DETAIL BS ON ODOT STANDARD DRAWING TM503.
- (5) INSTALL 1' WHITE STOP BAR PER DETAIL S ON ODOT STANDARD DRAWING TM503.
- (7) INSTALL WHITE LEFT TURN ARROW PER DETAIL LA ON ODOT STANDARD DRAWING TM501.

(9) INSTALL 4" YELLOW TWO-WAY LEFT TURN LINES WITH REFLECTORS PER DETAIL TWL/R-40 ON ODOT STANDARD DRAWING TM502.

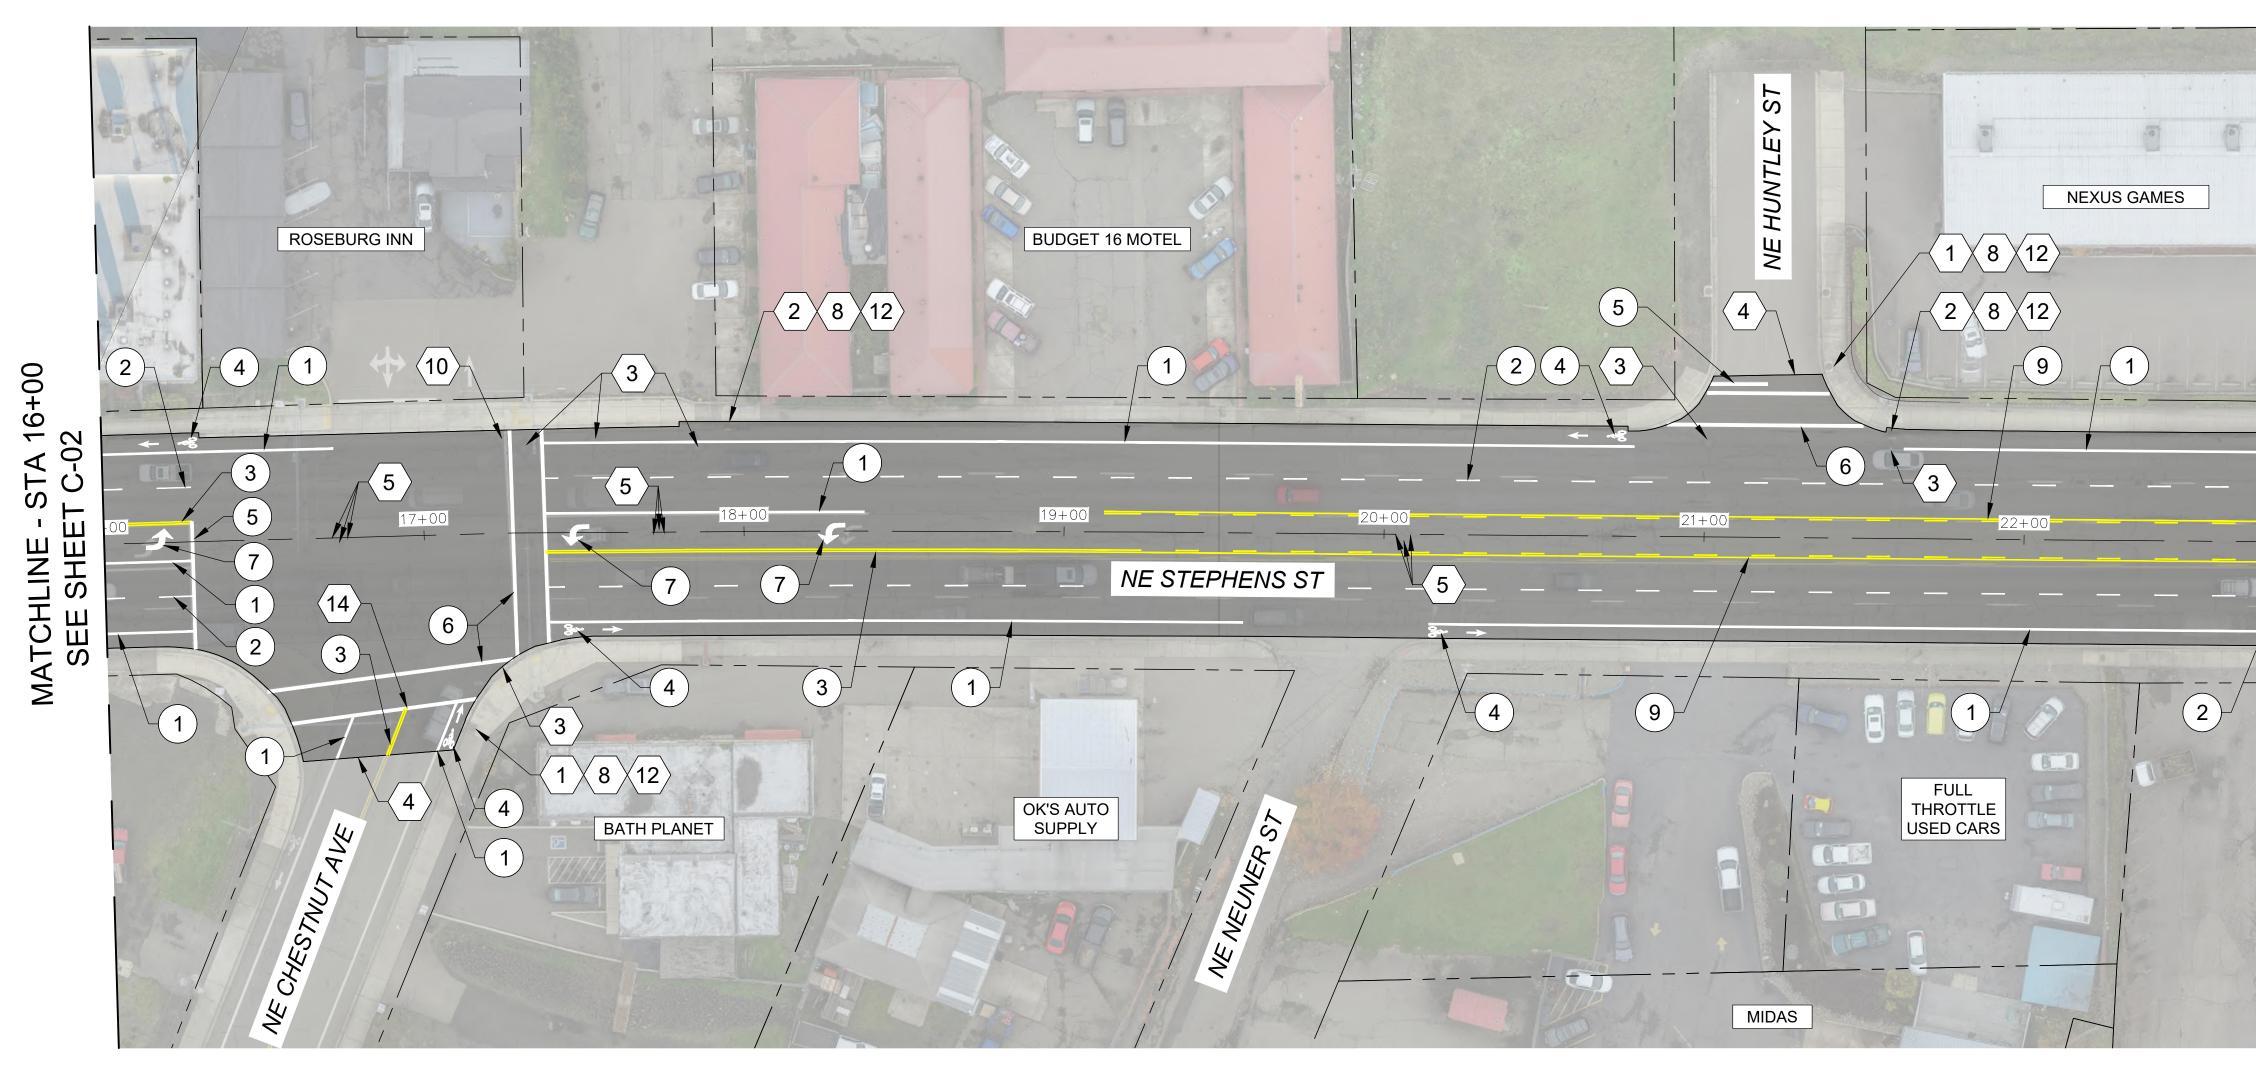

1. PAVE TO LIMITS SHOWN. SEE TYPICAL SECTION ON SHEET D-01.

2. APPLY LANE CLOSURES DURING PAVING OPERATIONS PER ODOT STANDARD DRAWING TM850, OR APPROVED TRAFFIC CONTROL PLAN.


LEGEND:



AC PAVING AND COLD PLANE PAVEMENT REMOVAL LIMITS. **SEE SECTION & DETAILS ON SHEETS** D-01 & D-02.

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				PROFILE	VERT.	CHECKED:	
						R. VOORHIES	REAL
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PLAN SCALE: 1"=30'

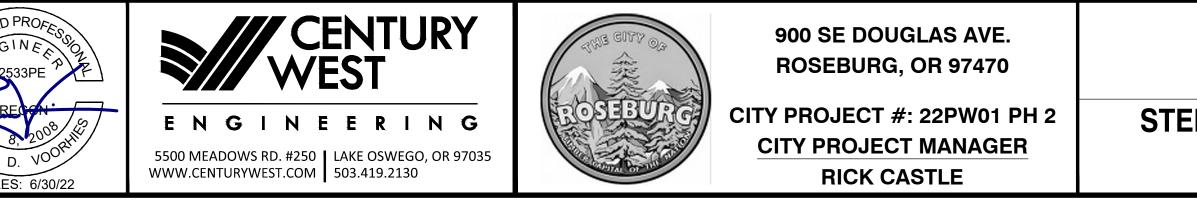

CONSTRUCTION KEYED NOTES:



 $\langle 1 \rangle$ Install inlet protection type 10 per odot standard DRAWING RD1010.



- $\langle 2 \rangle$ INSTALL INLET PROTECTION TYPE 3 PER ODOT STANDARD DRAWING RD1010.
- $\langle 3 \rangle$ LOWER EXISTING MANHOLE BELOW THE PROPOSED PAVING DEPTH PRIOR TO COLD PLANE PAVEMENT REMOVAL. ADJUST EXISTING STORM SEWER MANHOLE TO FINISH GRADE FOLLOWING PAVING OPERATIONS. SEE DETAIL 1 ON SHEET D-02.




- \langle 4 \rangle match existing grade. See details 2 & 3 on sheet D-02.
- < 5 > ADJUST EXISTING WATER VALVE BOX TO FINISH GRADE.
- $\langle 8 \rangle$ preserve & protect in place.
- <10> ADJUST EXISTING GAS VALVE BOX TO FINISH GRADE.
- $\langle 12 \rangle$ install storm drain marking stencil per detail 4 on SHEET D-02.

 $\langle 14 \rangle$ REPLACE EXISTING SURVEY MONUMENT BOX PER ODOT STANDARD DRAWING RD115.

PAVEMENT MARKING KEYED NOTES:

- INSTALL 8" WHITE LINE PER DETAIL W-2 ON ODOT 1) STANDARD DRAWING TM500.
- (2) INSTALL 4" WHITE BROKEN LINE WITH REFLECTORS PER DETAIL WB/R-40 ON ODOT STANDARD DRAWING TM502.
- (3) INSTALL 4" NARROW DOUBLE YELLOW LINES WITH REFLECTORS PER DETAIL ND/R-40 ON ODOT STANDARD DRAWING TM502.
- 4 INSTALL BICYCLE LANE STENCIL PER DETAIL BS ON ODOT STANDARD DRAWING TM503.
- (5) INSTALL 1' WHITE STOP BAR PER DETAIL S ON ODOT STANDARD DRAWING TM503.
- (6) INSTALL 1' WHITE STANDARD CROSSWALK BARS PER DETAIL CW ON ODOT STANDARD DRAWING TM503.
- (7) INSTALL WHITE LEFT TURN ARROW PER DETAIL LA ON ODOT STANDARD DRAWING TM501.
- (9) INSTALL 4" YELLOW TWO-WAY LEFT TURN LINES WITH REFLECTORS PER DETAIL TWL/R-40 ON ODOT STANDARD DRAWING TM502.

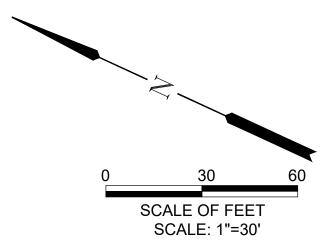

ROADWAY IMPROVEMENTS PLAN STA 16+00 TO STA 23+00


STEPHENS STREET PAVEMENT IMPROVEMENTS MAY 2022

7 OF 14

SHEET NO.

C-03

00+ 23 -04 INE - STA : SHEET C-(MATCHLINE -SEE SHE

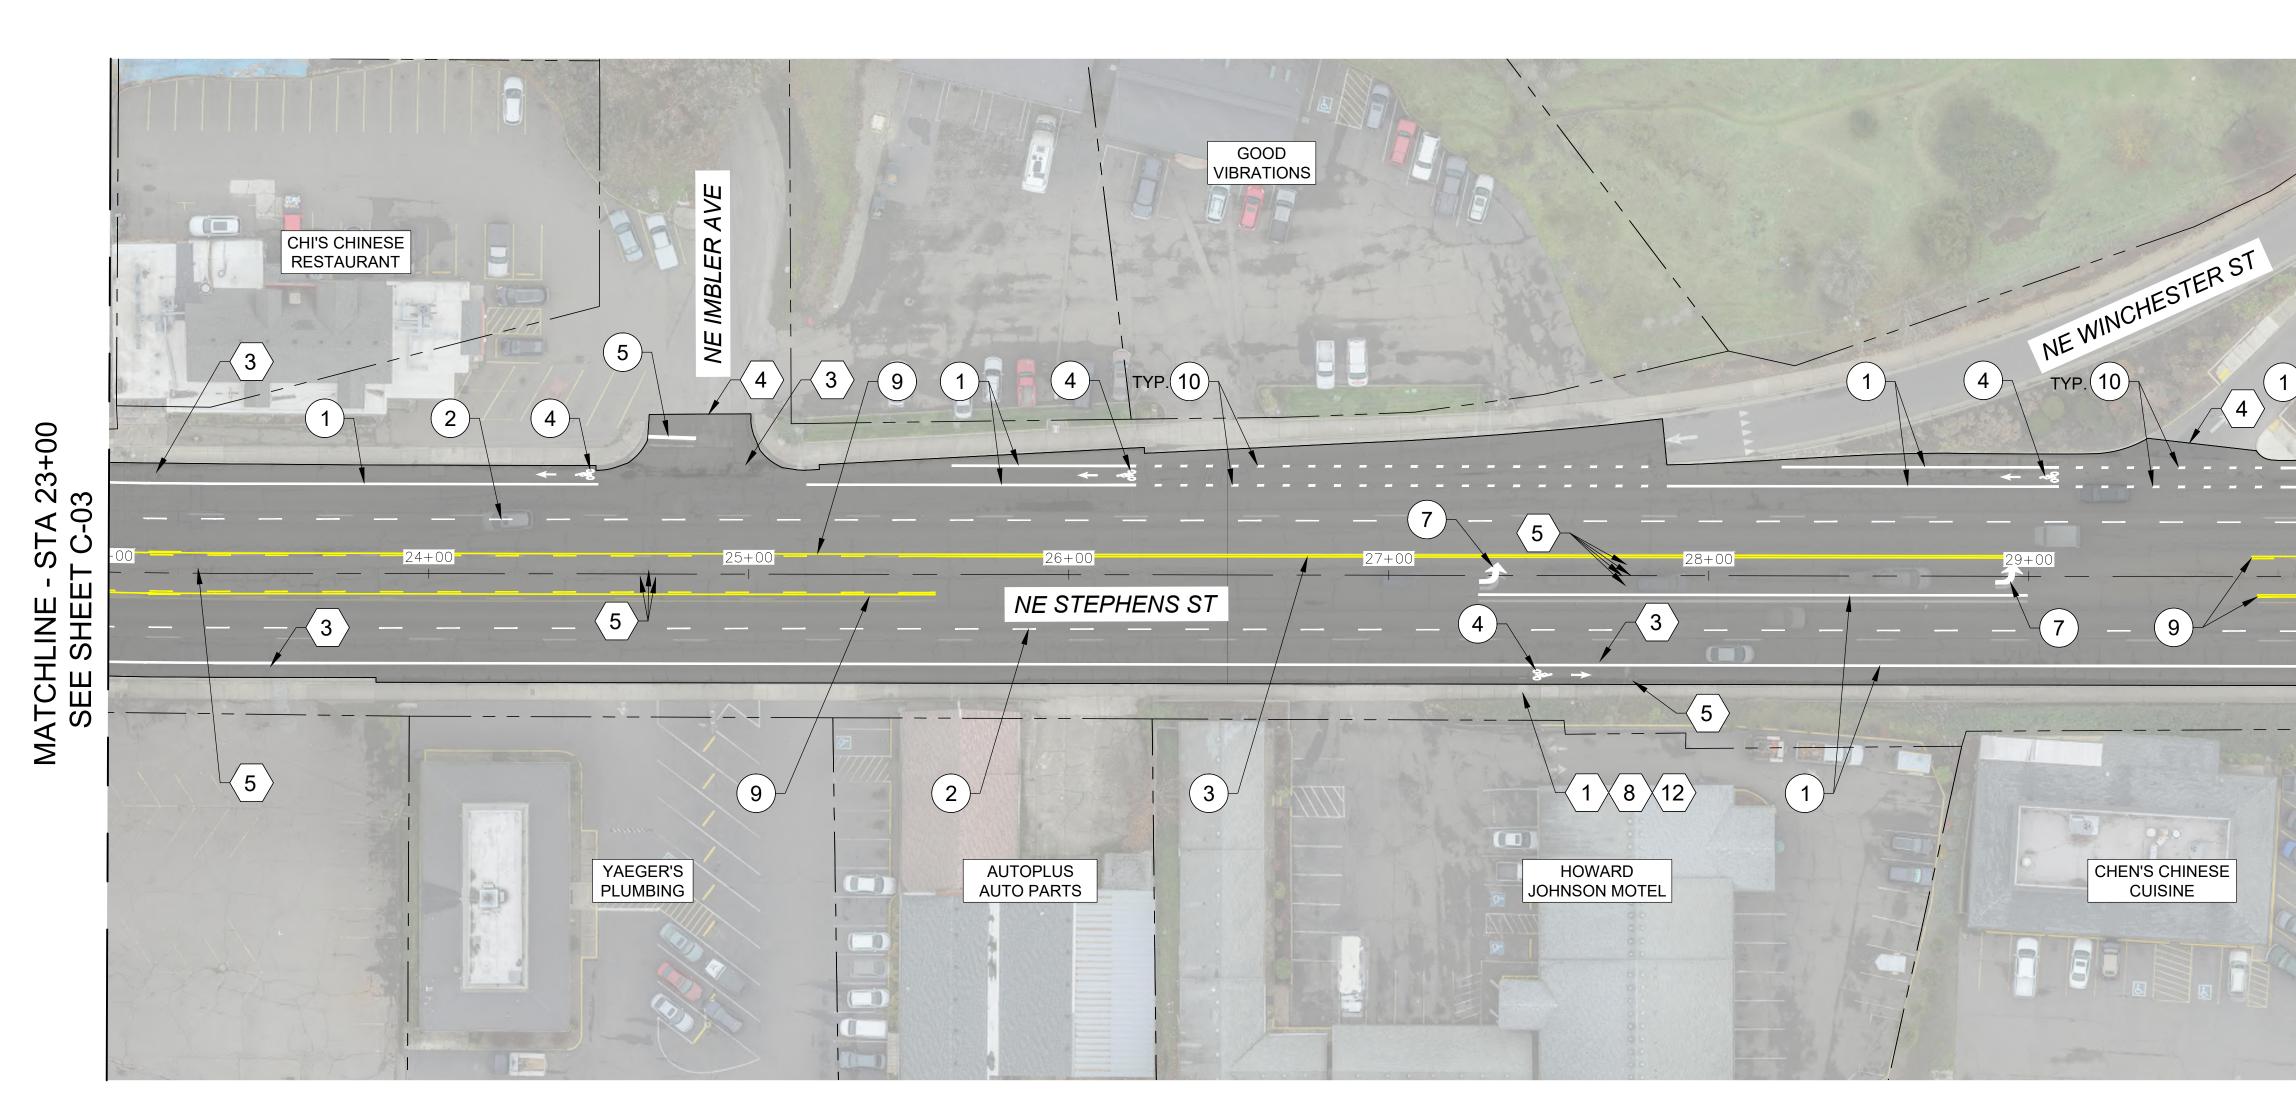

1. PAVE TO LIMITS SHOWN. SEE TYPICAL SECTION ON SHEET D-01.

2. APPLY LANE CLOSURES DURING PAVING OPERATIONS PER ODOT STANDARD DRAWING TM850, OR APPROVED TRAFFIC CONTROL PLAN.

LEGEND:




AC PAVING AND COLD PLANE PAVEMENT REMOVAL LIMITS. SEE SECTION & DETAILS ON SHEETS D-01 & D-02.


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				PROFILE	VERT.	CHECKED:	
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NRoseburg, City of 019-PMP TO7 2022 Design/CAD/Phase 2 - Paving/ WORKING/C-01 - C-04 - ROADWAY PLANS.dwg 5/11/2022 12:11 PM Alec

PLAN SCALE: 1"=30'

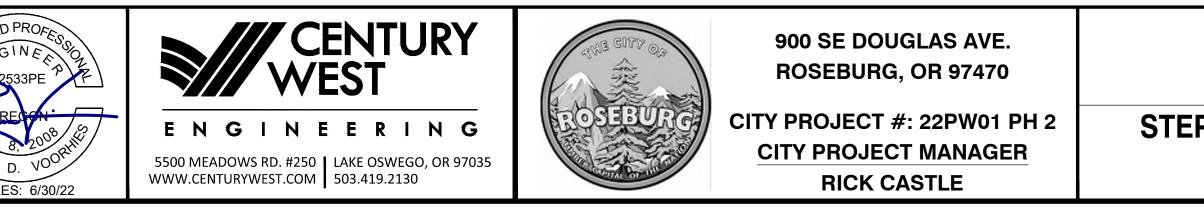

CONSTRUCTION KEYED NOTES:

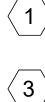

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MATCHLINE - S⁻ SEE SHEET INSTALL INLET PROTECTION TYPE 10 PER ODOT STANDARD DRAWING RD1010.

 LOWER EXISTING MANHOLE BELOW THE PROPOSED PAVING DEPTH PRIOR TO COLD PLANE PAVEMENT REMOVAL.
ADJUST EXISTING STORM SEWER MANHOLE TO FINISH GRADE FOLLOWING PAVING OPERATIONS. SEE DETAIL 1 ON SHEET D-02.

MATCH EXISTING GRADE. SEE DETAILS 2 & 3 ON SHEET D-02.



PRESERVE & PROTECT IN PLACE.

INSTALL STORM DRAIN MARKING STENCIL PER DETAIL 4 ON SHEET D-02.


PAVEMENT MARKING KEYED NOTES:

- 1 INSTALL 8" WHITE LINE PER DETAIL W-2 ON ODOT STANDARD DRAWING TM500.
- (2) INSTALL 4" WHITE BROKEN LINE WITH REFLECTORS PER DETAIL WB/R-40 ON ODOT STANDARD DRAWING TM502.
- (3) INSTALL 4" NARROW DOUBLE YELLOW LINES WITH REFLECTORS PER DETAIL ND/R-20 ON ODOT STANDARD DRAWING TM502.
- 4) INSTALL BICYCLE LANE STENCIL PER DETAIL BS ON ODOT STANDARD DRAWING TM503.
- (5) INSTALL 1' WHITE STOP BAR PER DETAIL S ON ODOT STANDARD DRAWING TM503.
- (7) INSTALL WHITE LEFT TURN ARROW PER DETAIL LA ON ODOT STANDARD DRAWING TM501.

(9) INSTALL 4" YELLOW TWO-WAY LEFT TURN LINES WITH REFLECTORS PER DETAIL TWL/R-40 ON ODOT STANDARD DRAWING TM502.

(10) INSTALL 8" WHITE DOTTED LINE PER DETAIL WD-2 ON ODOT STANDARD DRAWING TM500.

0306003060SCALE OF FEET
SCALE: 1"=30'SCALE OF FEET
SCALE: 1"=30'ROADWAY IMPROVEMENTS PLAN
STA 23+00 TO STA 30+00SHEET NO.C-04STEPHENS STREET PAVEMENT IMPROVEMENTS
MAY 20228 OF 14

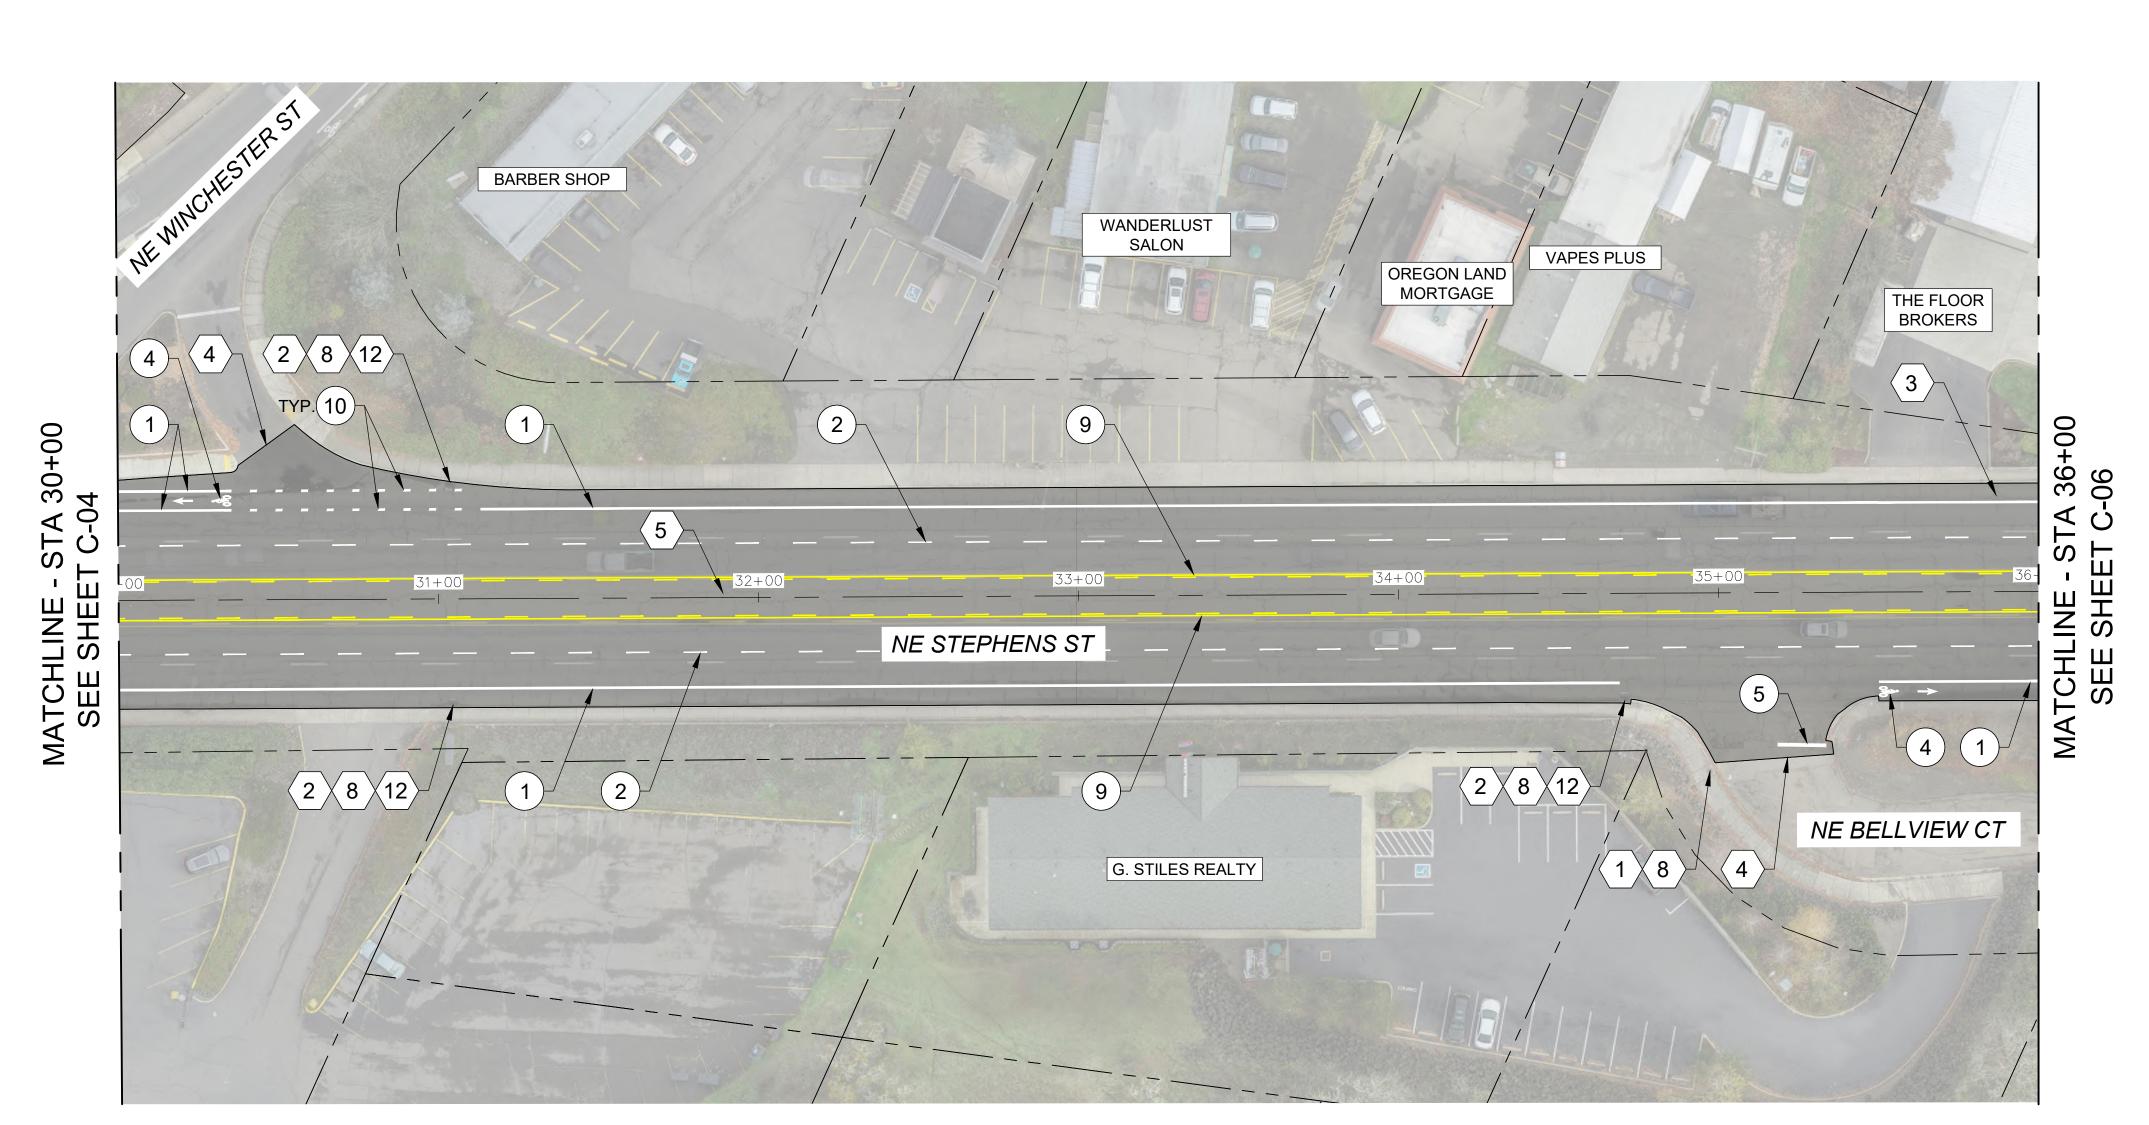

1. PAVE TO LIMITS SHOWN. SEE TYPICAL SECTION ON SHEET D-01.

2. APPLY LANE CLOSURES DURING PAVING OPERATIONS PER ODOT STANDARD DRAWING TM850, OR APPROVED TRAFFIC CONTROL PLAN.


LEGEND:



AC PAVING AND COLD PLANE PAVEMENT REMOVAL LIMITS. **SEE SECTION & DETAILS ON SHEETS** D-01 & D-02.

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					HORIZ.	E. WILSON	1
				PROFILE	VERT.	CHECKED:	
				R. VOORHIES	12		
				ONE II	NCH (REF)	CWE PROJECT NO.	
						40193.019.01	

PLAN SCALE: 1"=30'

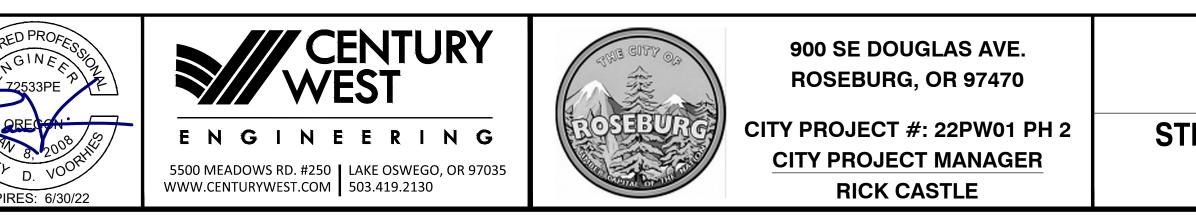

CONSTRUCTION KEYED NOTES:



 $\langle 1 \rangle$ INSTALL INLET PROTECTION TYPE 10 PER ODOT STANDARD DRAWING RD1010.



 $\langle 2 \rangle$ INSTALL INLET PROTECTION TYPE 3 PER ODOT STANDARD DRAWING RD1010.

 $\langle 3 \rangle$ lower existing manhole below the PROPOSED PAVING DEPTH PRIOR TO COLD PLANE PAVEMENT REMOVAL. ADJUST EXISTING STORM SEWER MANHOLE TO FINISH GRADE FOLLOWING PAVING OPERATIONS. SEE DETAIL 1 ON SHEET D-02.



 $\langle 4 \rangle$ MATCH EXISTING GRADE. SEE DETAILS 2 & 3 ON SHEET D-02.



5 ADJUST EXISTING WATER VALVE BOX TO FINISH GRADE.



 $\langle 8 \rangle$ preserve & protect in place.

 $\langle 12 \rangle$ install storm drain marking stencil per DETAIL 4 ON SHEET D-02.

PAVEMENT MARKING KEYED NOTES:



(1) INSTALL 8" WHITE LINE PER DETAIL W-2 ON ODOT STANDARD DRAWING TM500.


- (2) INSTALL 4" WHITE BROKEN LINE WITH REFLECTORS PER DETAIL WB/R-40 ON ODOT STANDARD DRAWING TM502.
- (4) INSTALL BICYCLE LANE STENCIL PER DETAIL BS ON ODOT STANDARD DRAWING TM503.



(5) INSTALL 1' WHITE STOP BAR PER DETAIL S ON ODOT STANDARD DRAWING TM503.

(9) INSTALL 4" YELLOW TWO-WAY LEFT TURN LINES WITH REFLECTORS PER DETAIL TWL/R-40 ON ODOT STANDARD DRAWING TM502.

(10) INSTALL 8" WHITE DOTTED LINE PER DETAIL WD-2 ON ODOT STANDARD DRAWING TM500.

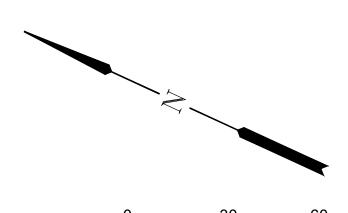

SHEET NO.


SCALE OF FEET SCALE: 1"=30'

ROADWAY IMPROVEMENTS PLAN STA 30+00 TO STA 36+00

STEPHENS STREET PAVEMENT IMPROVEMENTS MAY 2022

9 OF 14

C-05

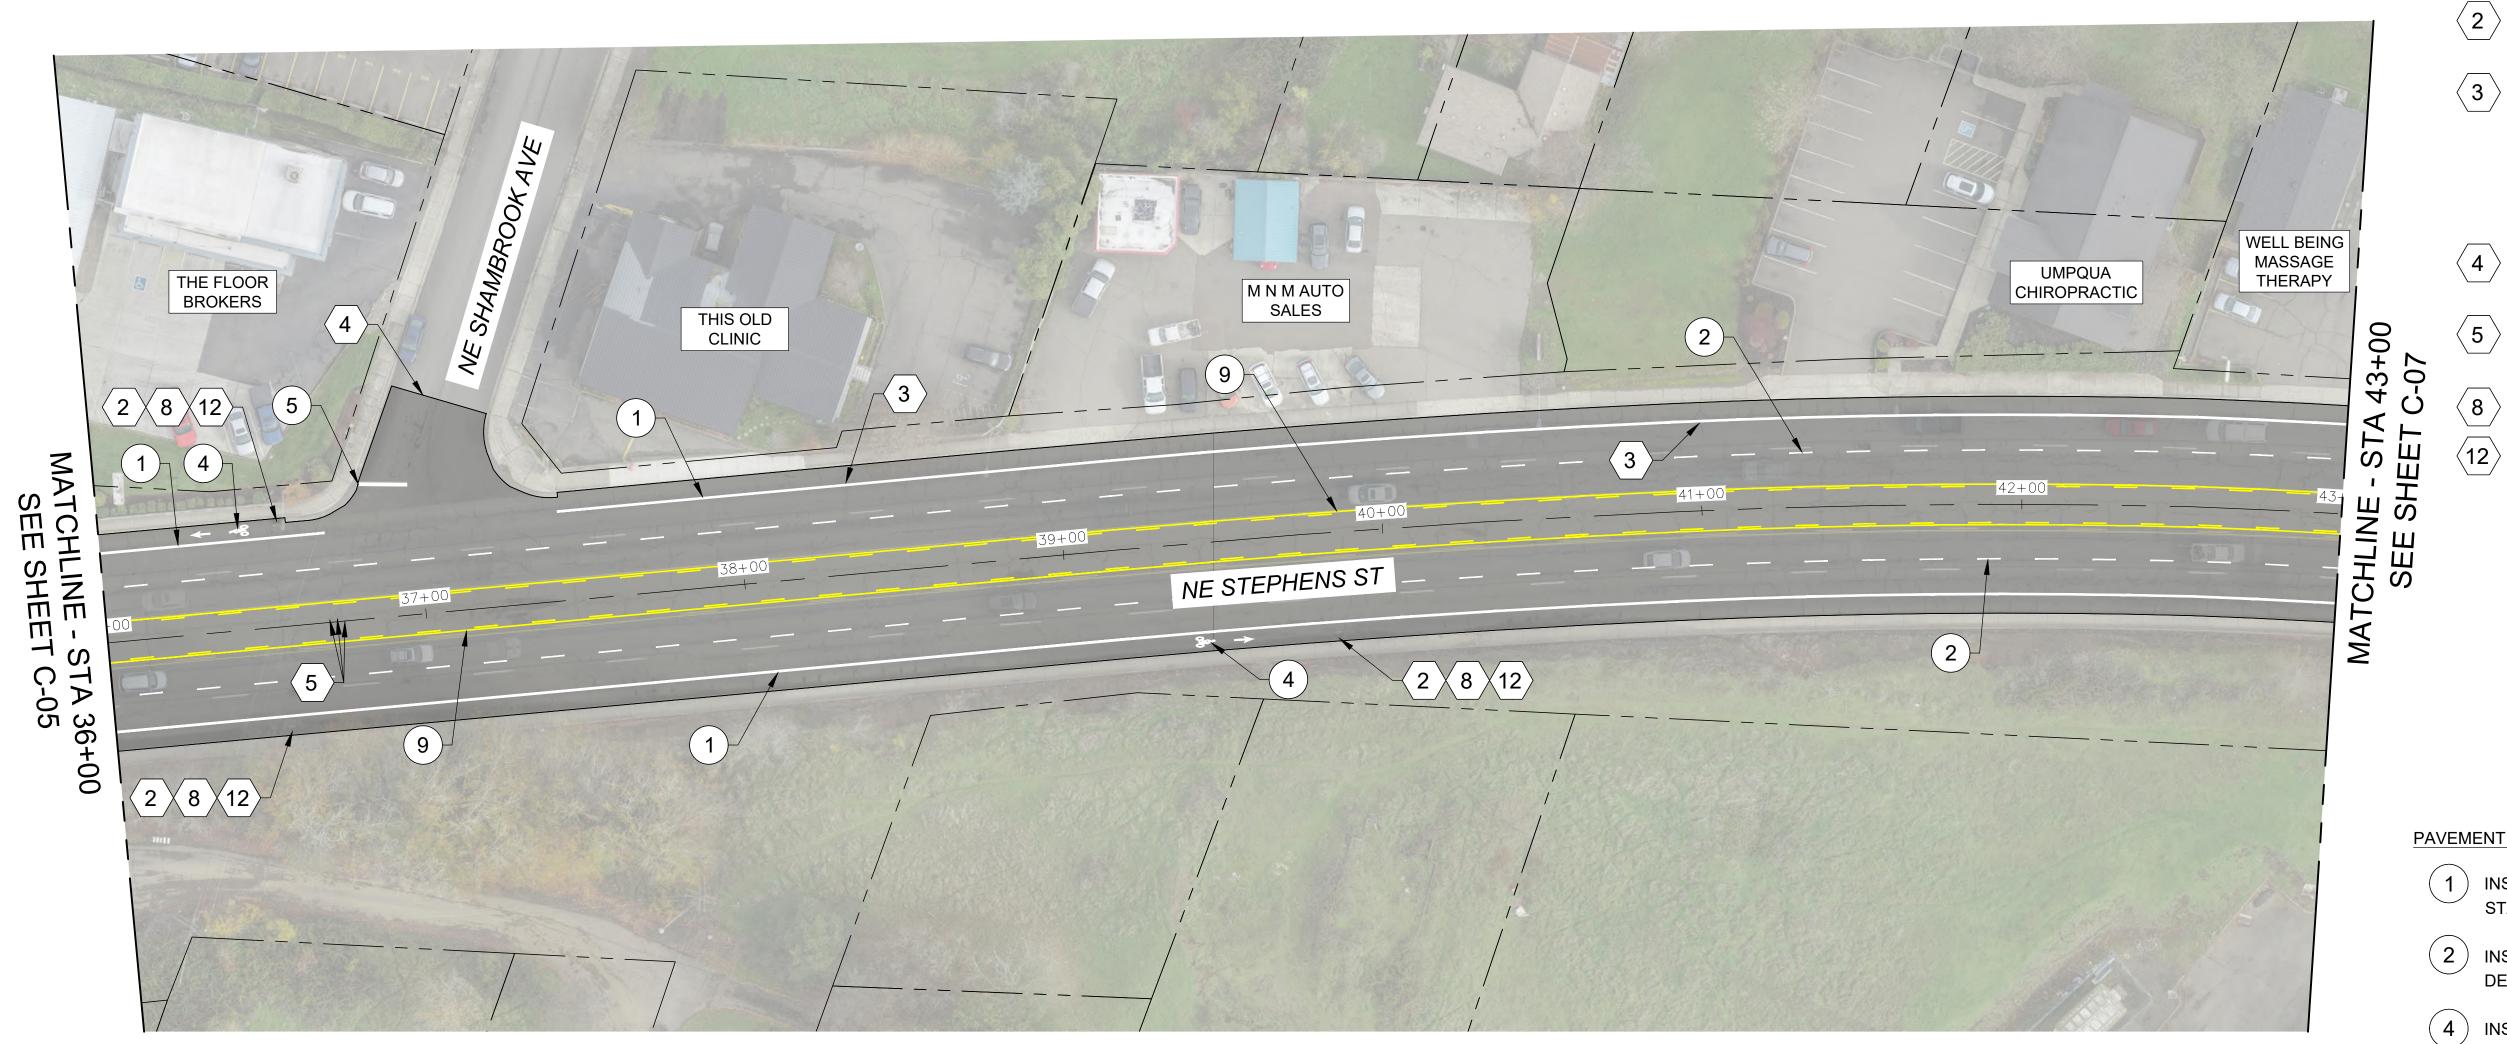

1. PAVE TO LIMITS SHOWN. SEE TYPICAL SECTION ON SHEET D-01.

2. APPLY LANE CLOSURES DURING PAVING OPERATIONS PER ODOT STANDARD DRAWING TM850, OR APPROVED TRAFFIC CONTROL PLAN.

LEGEND:




AC PAVING AND COLD PLANE PAVEMENT REMOVAL LIMITS. SEE SECTION & DETAILS ON SHEETS D-01 & D-02.

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				PROFILE	VERT.	CHECKED:	
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\Roseburg, City of\019-PMP TO7 2022 Design\CAD\Phase 2 - Paving_WORKING\C-05 - C-07 - ROADWAY PLANS.dwg_5/11/2022 12:13 PM_Ale



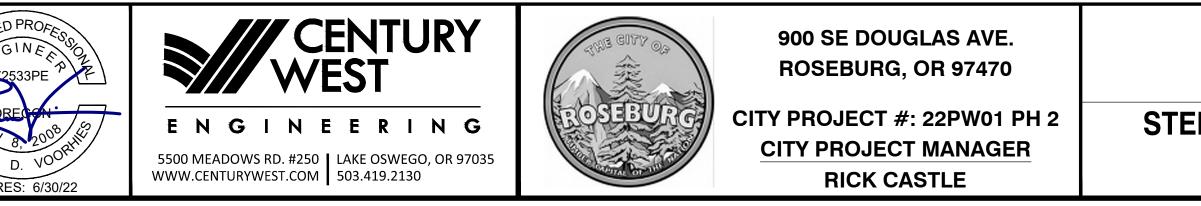


CONSTRUCTION KEYED NOTES:

- > INSTALL INLET PROTECTION TYPE 3 PER ODOT STANDARD DRAWING RD1010.
- 3 LOWER EXISTING MANHOLE BELOW THE PROPOSED PAVING DEPTH PRIOR TO COLD PLANE PAVEMENT REMOVAL. ADJUST EXISTING STORM SEWER MANHOLE TO FINISH GRADE FOLLOWING PAVING OPERATIONS. SEE DETAIL 1 ON SHEET D-02.
 - MATCH EXISTING GRADE. SEE DETAILS 2 & 3 ON SHEET D-02.
 - ADJUST EXISTING WATER VALVE BOX TO FINISH GRADE.
 - PRESERVE & PROTECT IN PLACE.
 - INSTALL STORM DRAIN MARKING STENCIL PER DETAIL 4 ON SHEET D-02.

PAVEMENT MARKING KEYED NOTES:

- 1 INSTALL 8" WHITE LINE PER DETAIL W-2 ON ODOT STANDARD DRAWING TM500.
- INSTALL 4" WHITE BROKEN LINE WITH REFLECTORS PER DETAIL WB/R-40 ON ODOT STANDARD DRAWING TM502.
- 4) INSTALL BICYCLE LANE STENCIL PER DETAIL BS ON ODOT STANDARD DRAWING TM503.
- 5 INSTALL 1' WHITE STOP BAR PER DETAIL S ON ODOT STANDARD DRAWING TM503.
- (9) INSTALL 4" YELLOW TWO-WAY LEFT TURN LINES WITH REFLECTORS PER DETAIL TWL/R-40 ON ODOT STANDARD DRAWING TM502.

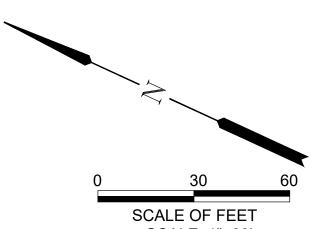

SCALE OF FEET SCALE: 1"=30'


ROADWAY IMPROVEMENTS PLAN STA 36+00 TO STA 43+00

STEPHENS STREET PAVEMENT IMPROVEMENTS MAY 2022

10 OF 14

SHEET NO.

C-06

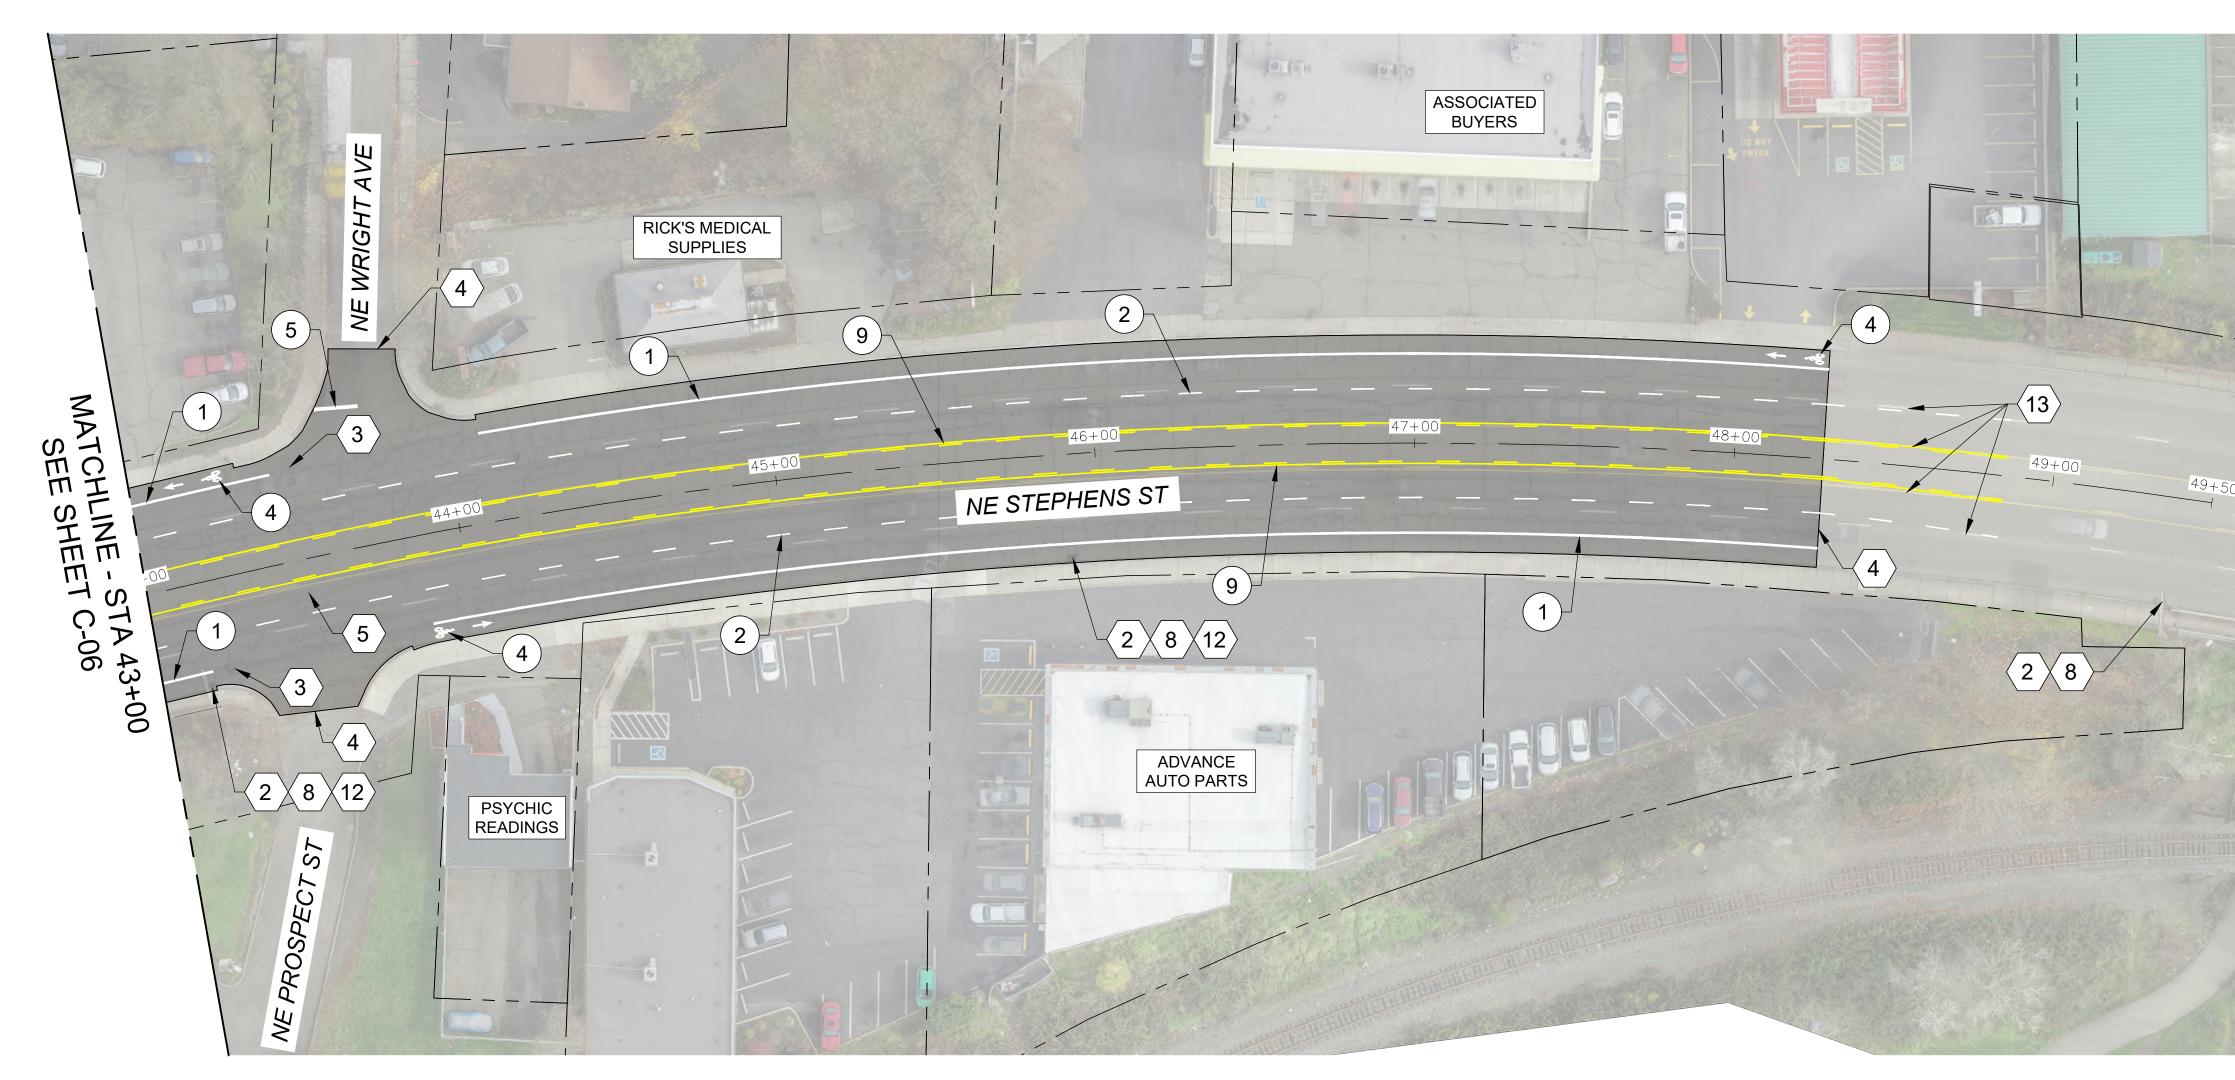

1. PAVE TO LIMITS SHOWN. SEE TYPICAL SECTION ON SHEET D-01.

2. APPLY LANE CLOSURES DURING PAVING OPERATIONS PER ODOT STANDARD DRAWING TM850, OR APPROVED TRAFFIC CONTROL PLAN.


LEGEND:



AC PAVING AND COLD PLANE PAVEMENT REMOVAL LIMITS. SEE SECTION & DETAILS ON SHEETS D-01 & D-02.

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					HORIZ.	E. WILSON	101
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						R. VOORHIES	RIM
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PLAN SCALE: 1"=30'

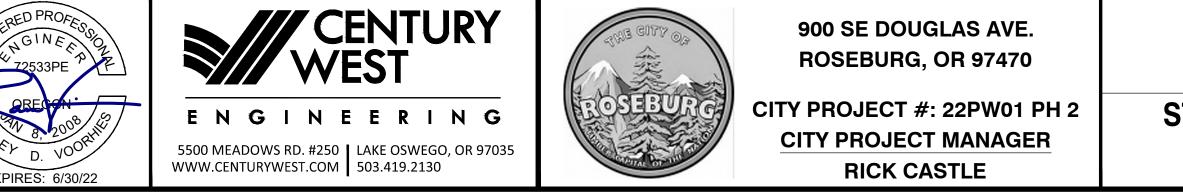

CONSTRUCTION KEYED NOTES:



INSTALL INLET PROTECTION TYPE 3 PER ODOT STANDARD DRAWING RD1010.

(3)

LOWER EXISTING MANHOLE BELOW THE PROPOSED PAVING DEPTH PRIOR TO COLD PLANE PAVEMENT REMOVAL. ADJUST EXISTING STORM SEWER MANHOLE TO FINISH GRADE FOLLOWING PAVING OPERATIONS. SEE DETAIL 1 ON SHEET D-02.

MATCH EXISTING GRADE. SEE DETAILS 2 & 3 ON SHEET D-02.



(4)

ADJUST EXISTING WATER VALVE BOX TO FINISH GRADE.



PRESERVE & PROTECT IN PLACE.

 $\langle 12 \rangle$ $\langle 13 \rangle$

DETAIL 4 ON SHEET D-02. REMOVE EXISTING STRIPING WITHIN LIMITS OF

INSTALL STORM DRAIN MARKING STENCIL PER

NEW STRIPING SHOWN. VERIFY EXTENTS WITH ENGINEER PRIOR TO REMOVAL.

PAVEMENT MARKING KEYED NOTES:



(1) INSTALL 8" WHITE LINE PER DETAIL W-2 ON ODOT STANDARD DRAWING TM500.



(2) INSTALL 4" WHITE BROKEN LINE WITH REFLECTORS PER DETAIL WB/R-40 ON ODOT STANDARD DRAWING TM502.




(4) INSTALL BICYCLE LANE STENCIL PER DETAIL BS ON ODOT STANDARD DRAWING TM503.



(5) INSTALL 1' WHITE STOP BAR PER DETAIL S ON ODOT STANDARD DRAWING TM503.



(9) INSTALL 4" YELLOW TWO-WAY LEFT TURN LINES WITH REFLECTORS PER DETAIL TWL/R-40 ON ODOT STANDARD DRAWING TM502.

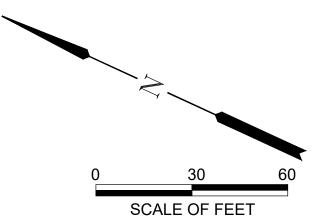

SCALE: 1"=30'

ROADWAY IMPROVEMENTS PLAN STA 43+00 TO STA 49+50

STEPHENS STREET PAVEMENT IMPROVEMENTS MAY 2022


SHEET NO.


C-07

NO.	DATE	BY	REVISION	S	CALE	DESIGNED:	
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						E. WILSON	1
				PROFILE	VERT.	CHECKED:	
						R. VOORHIES	
					NCH (REF)	CWE PROJECT NO.	
						40193.019.01	


STEPHENS STREET TYPICAL SECTION

TACK COAT ALL ACP SURFACES $-\!\!\!\!/$ TO RECEIVE NEW ACP

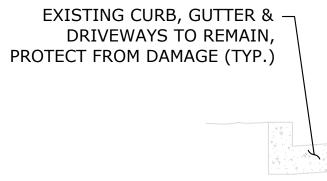

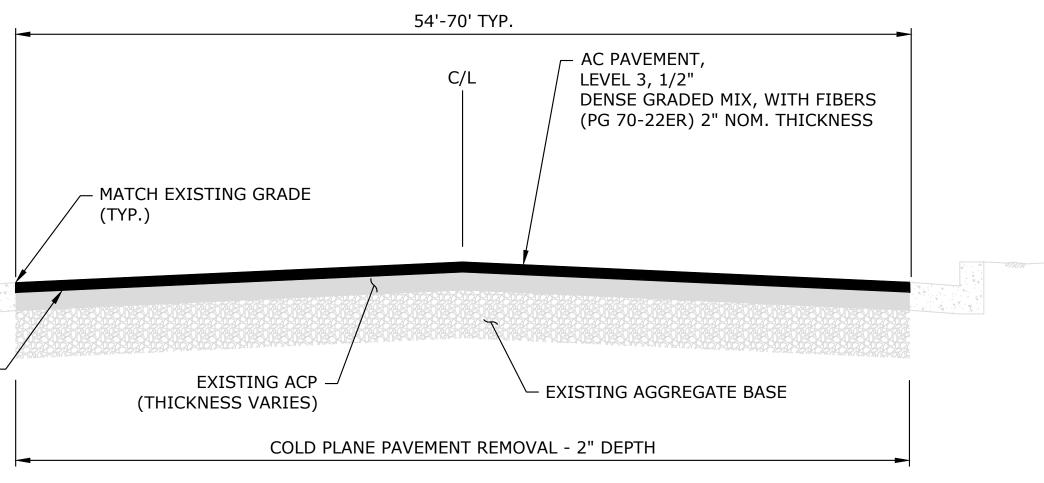



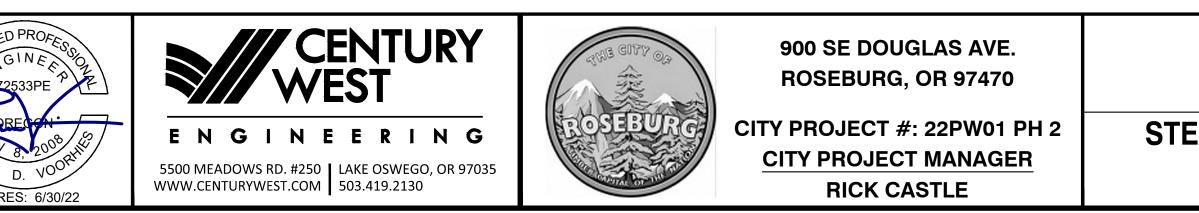


STEPHENS STREET PAVEMENT IMPROVEMENTS MAY 2022

12 OF 14

D-01

SHEET NO.


TYPICAL SECTIONS

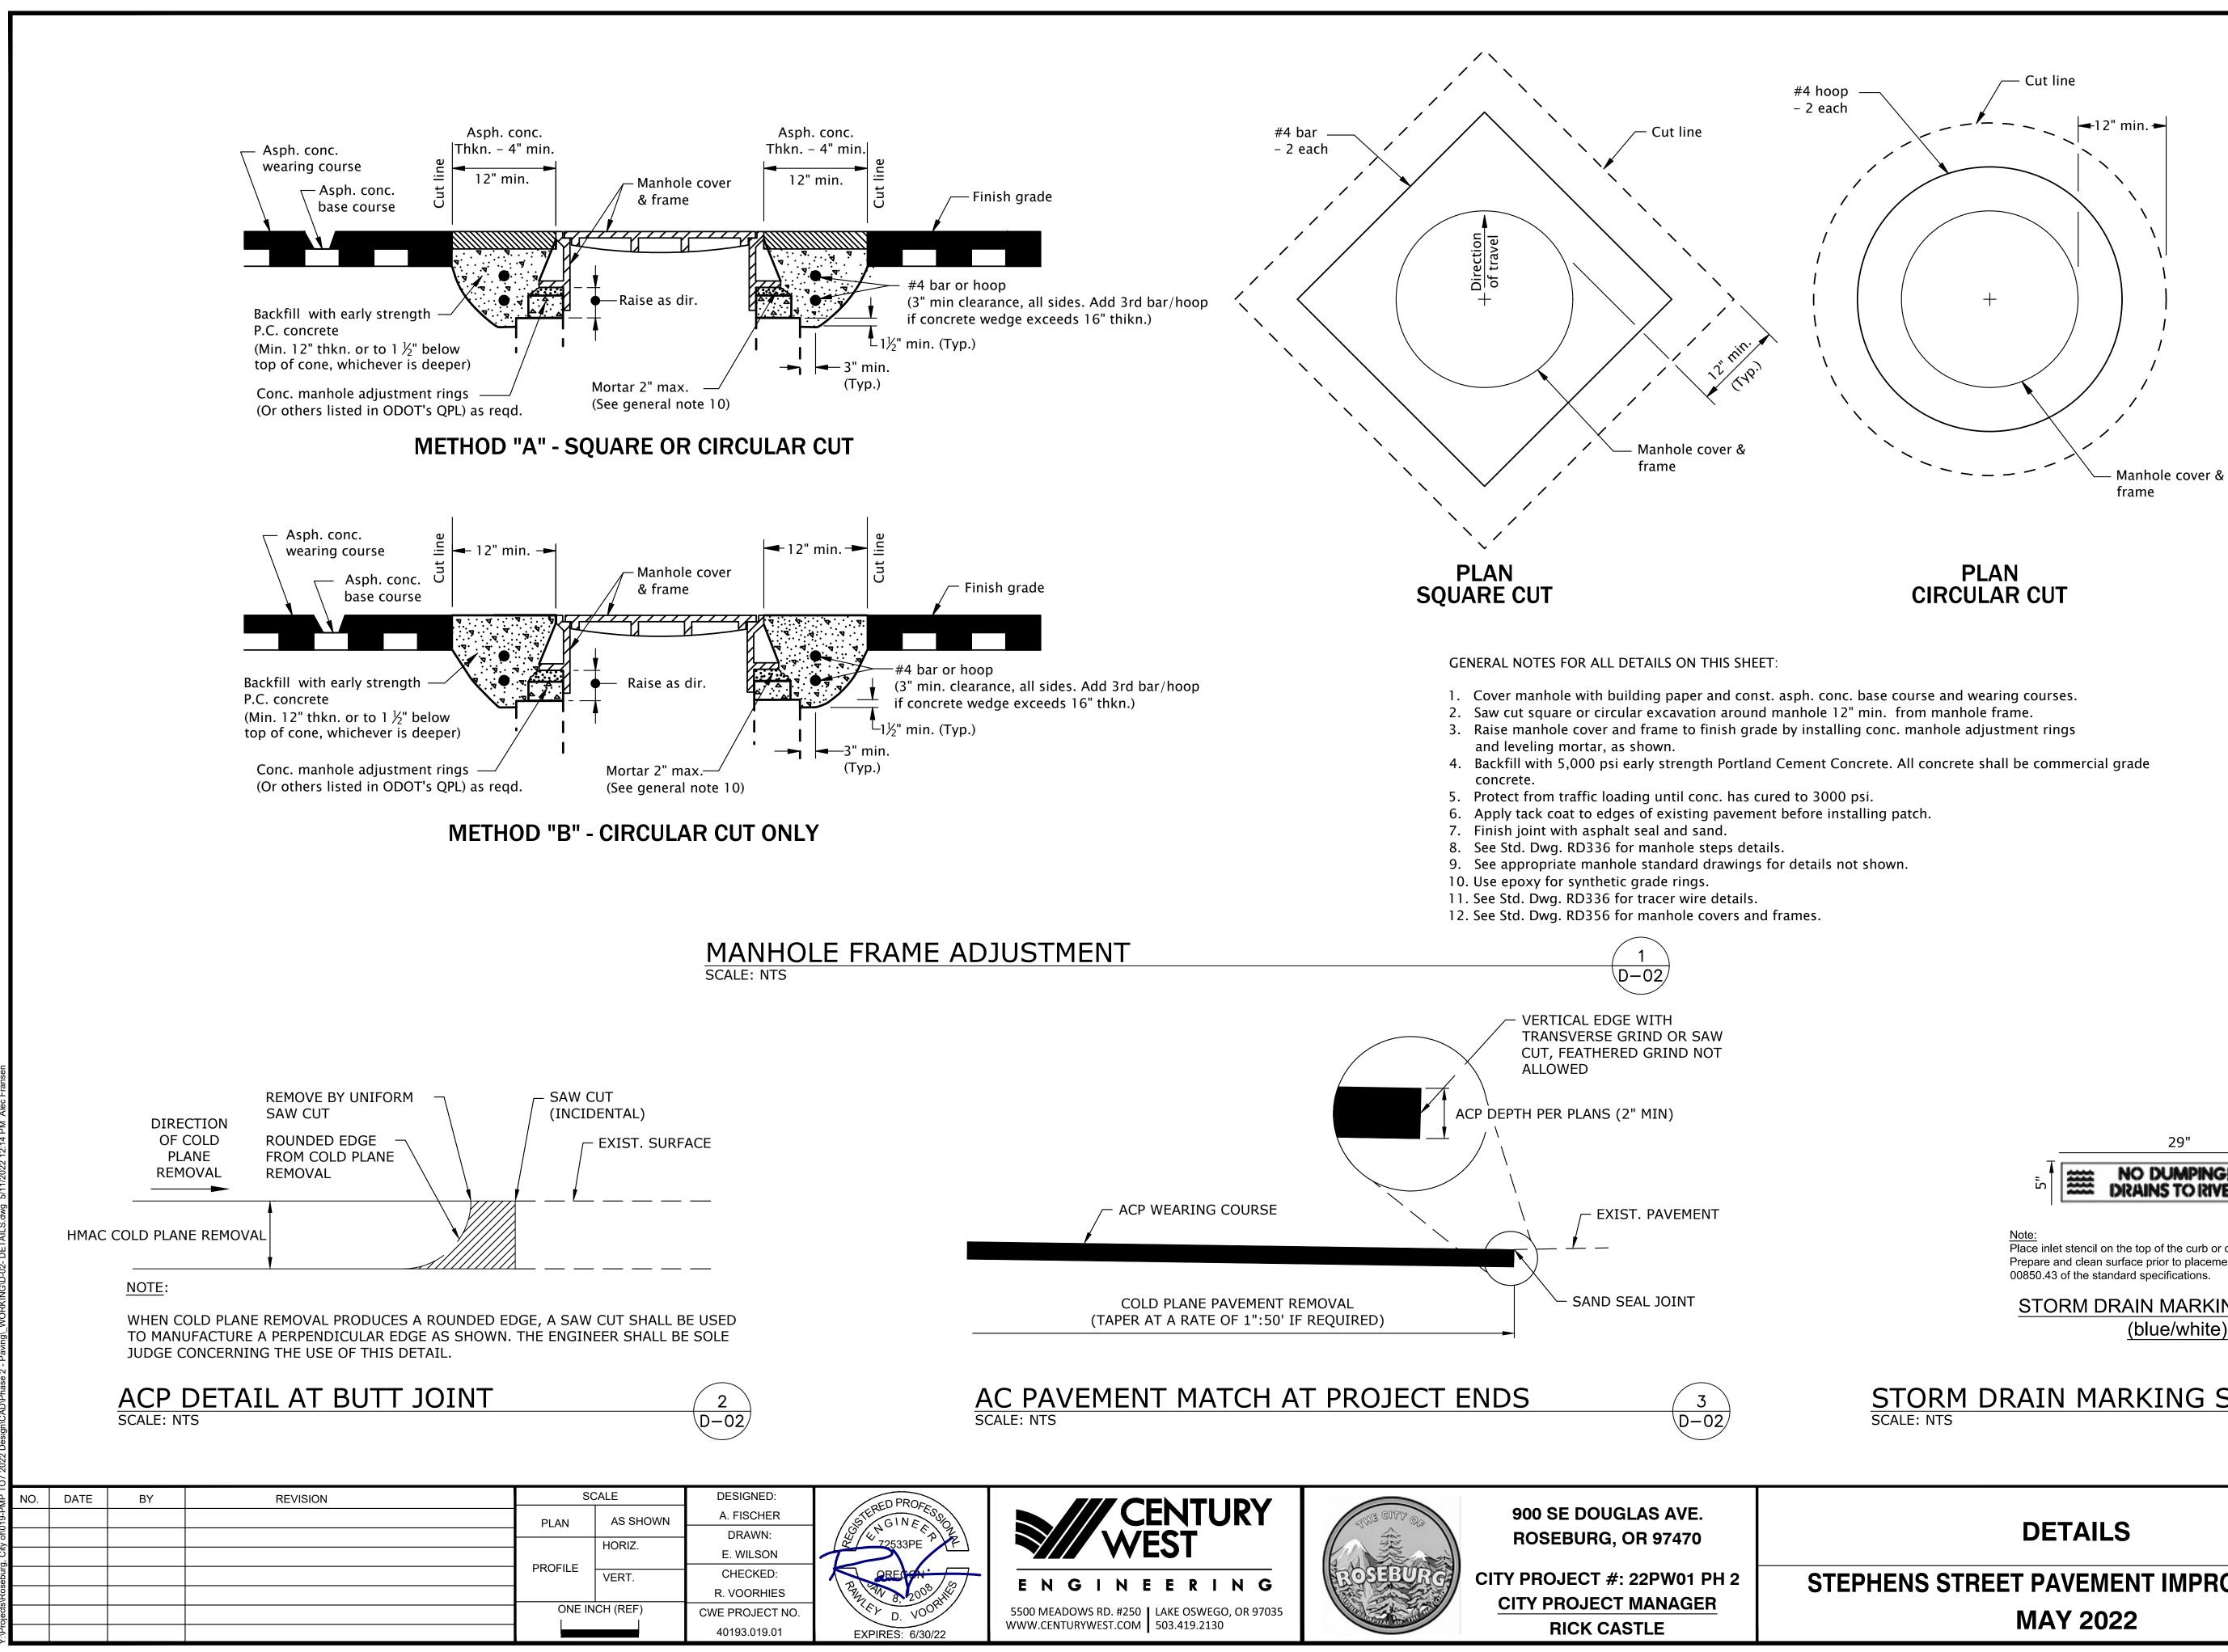


STEPHENS STREET PAVEMENT IMPROVEMENTS 13 OF 14

Note: Place inlet stencil on the top of the curb or concrete inlet as directed. Prepare and clean surface prior to placement in accordance with section STORM DRAIN MARKING STENCIL (blue/white) STORM DRAIN MARKING STENCIL 4 D-02 SHEET NO. D-02


NO DUMPING! DRAINS TO RIVER

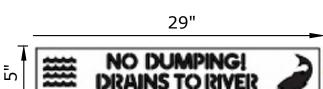



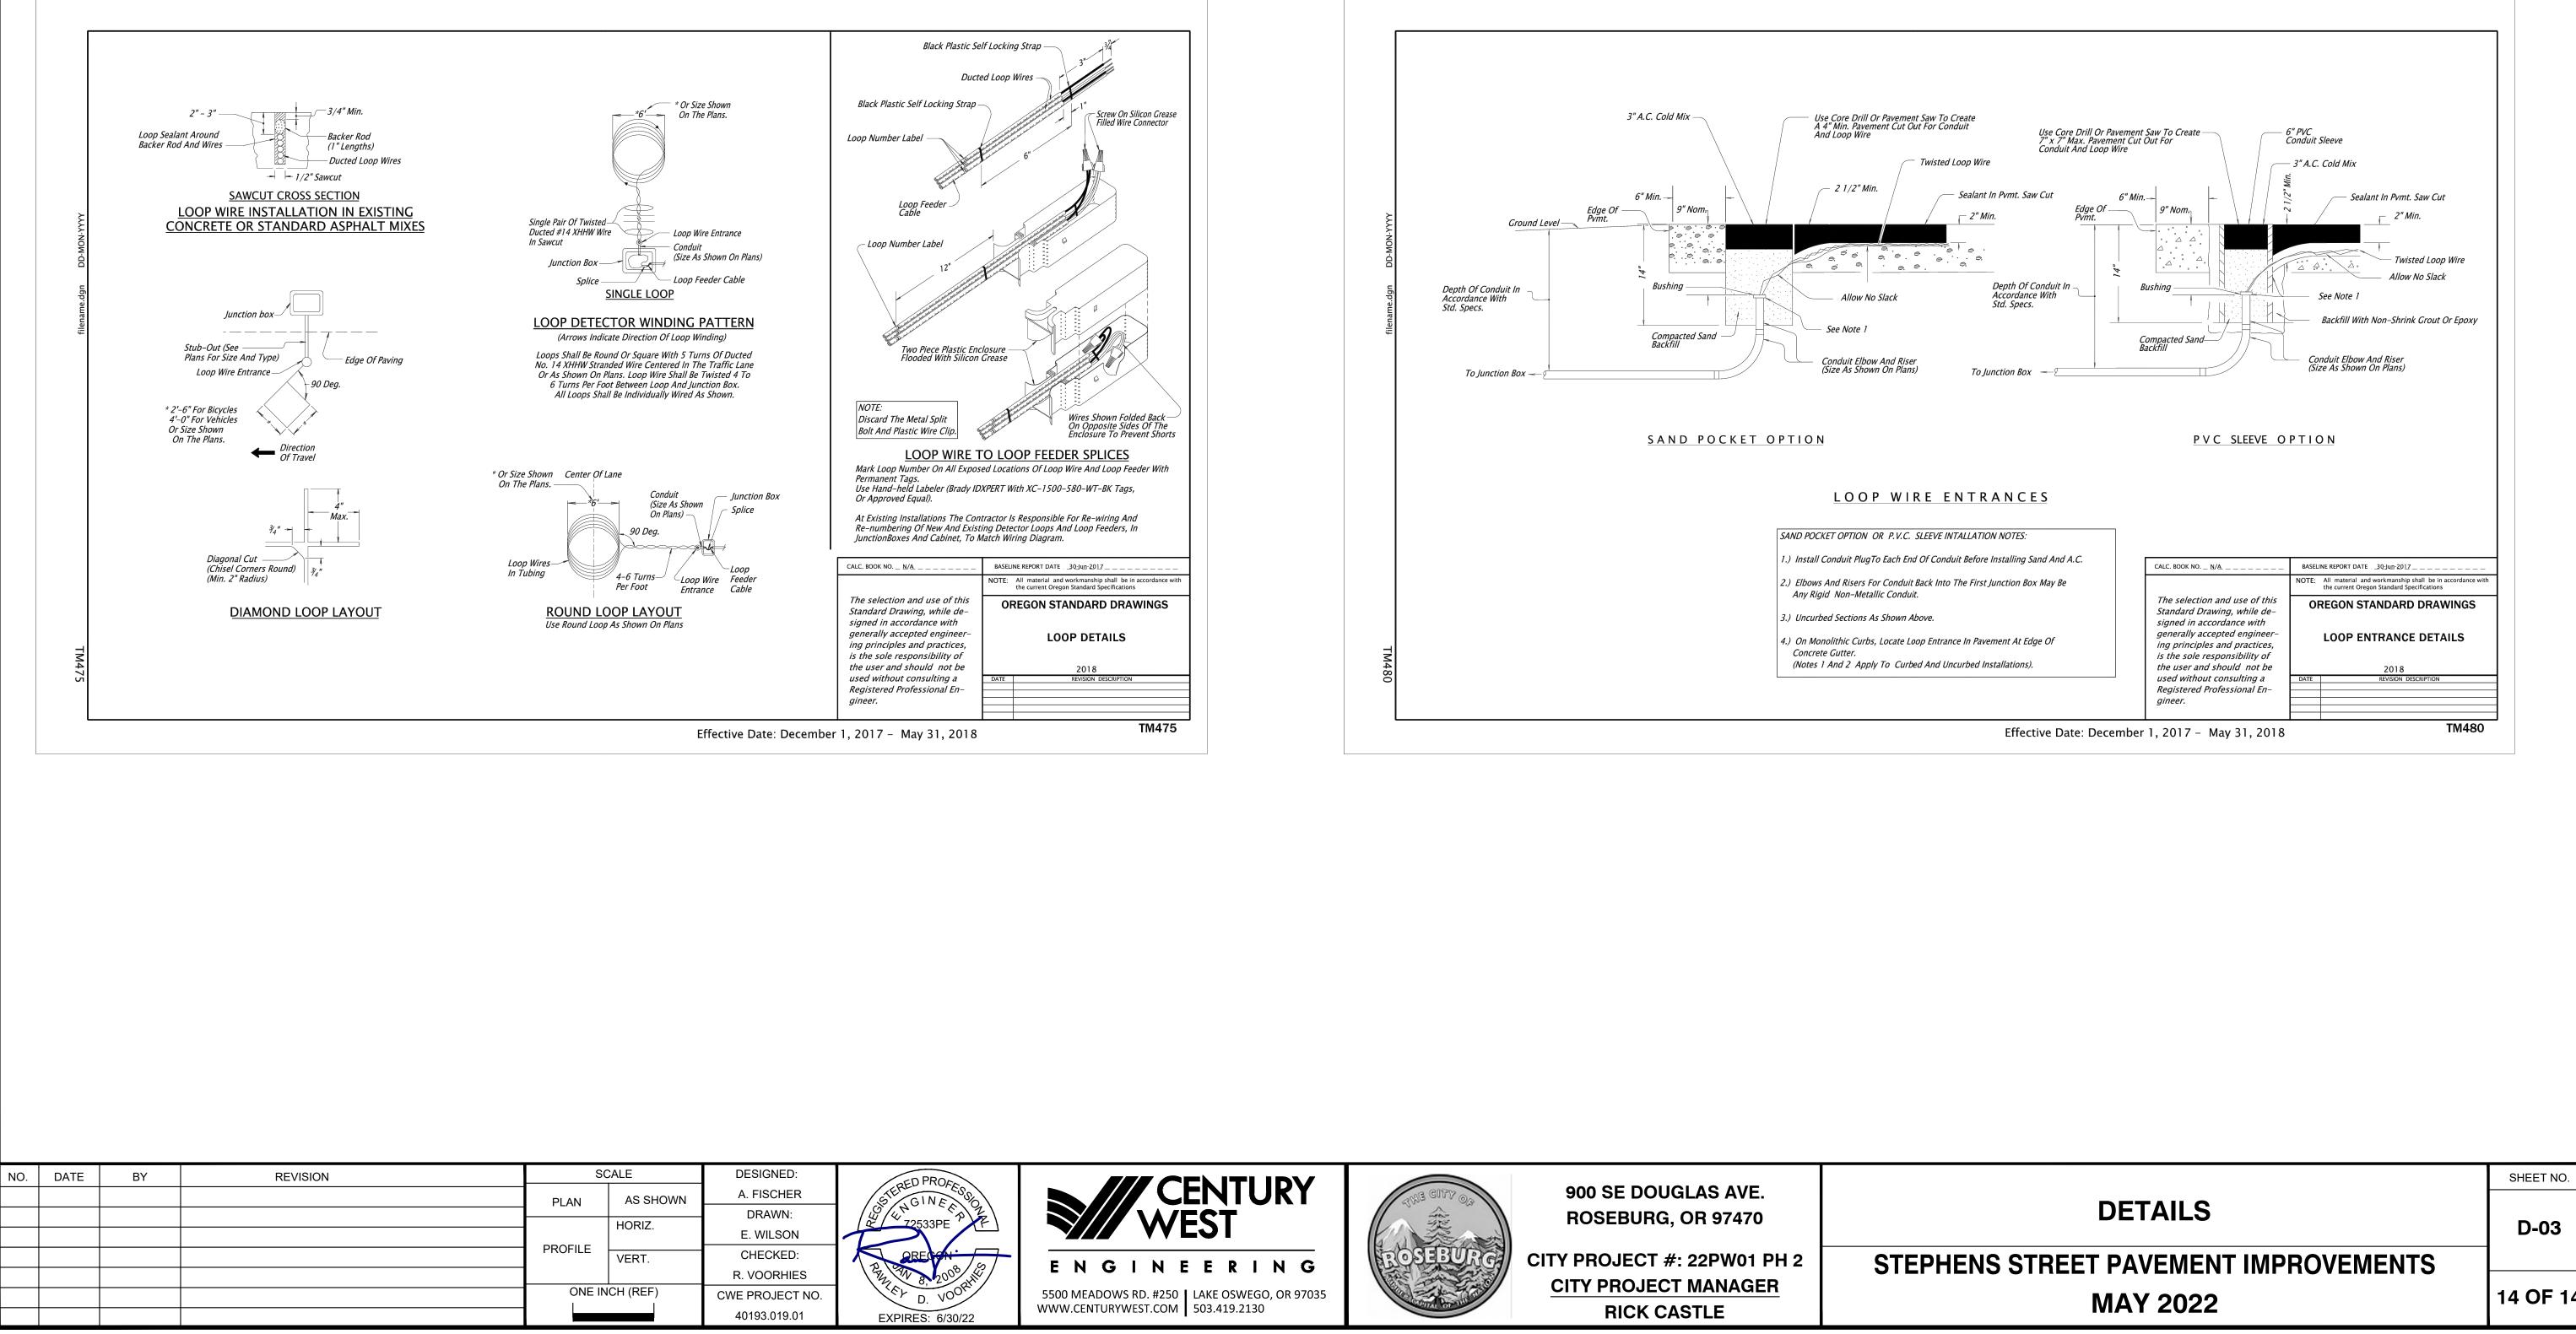



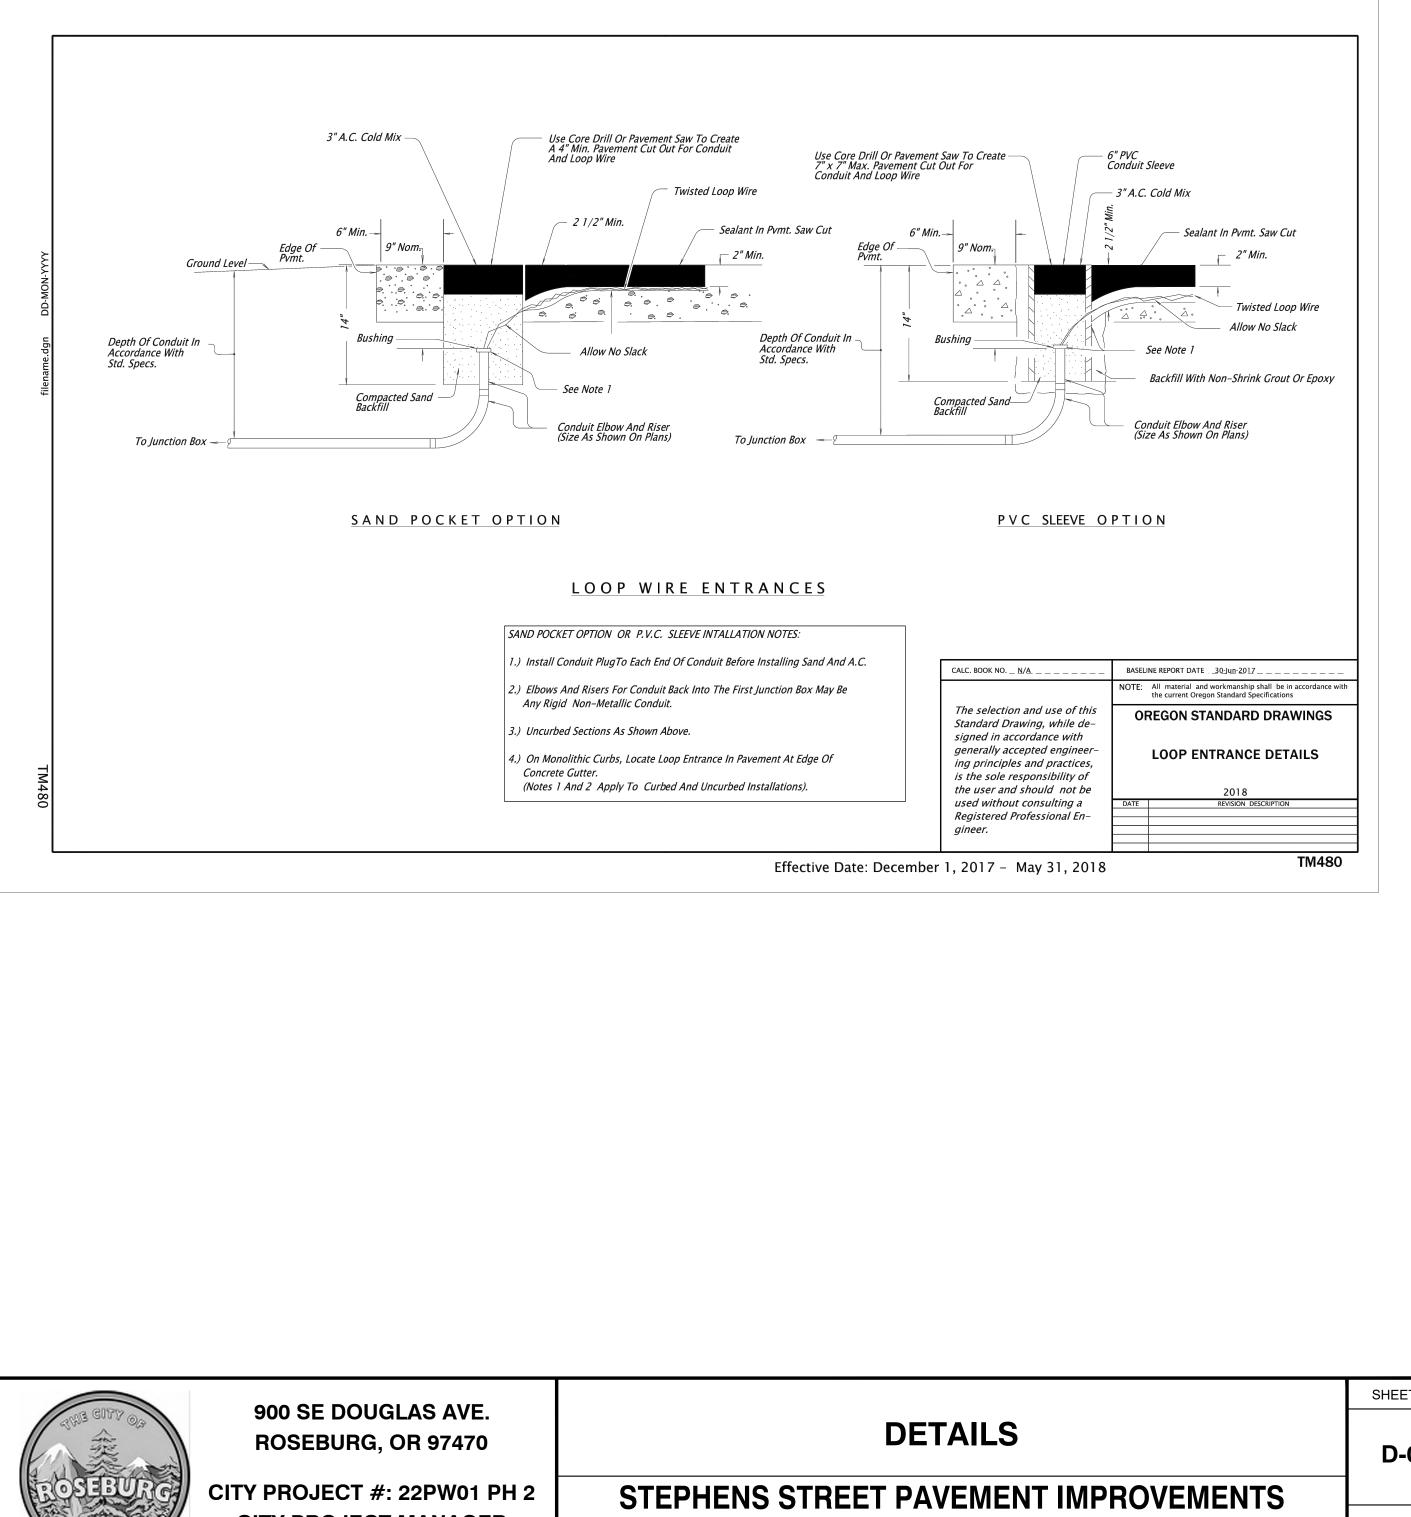

14 OF 14